

CAL POLY HUMBOLDT SIEMENS HALL

ROOF REPLACEMENT

1 HARPST ST
ARCATE, CA 95521

100% CONSTRUCTION DOCUMENTS
03/27/2025

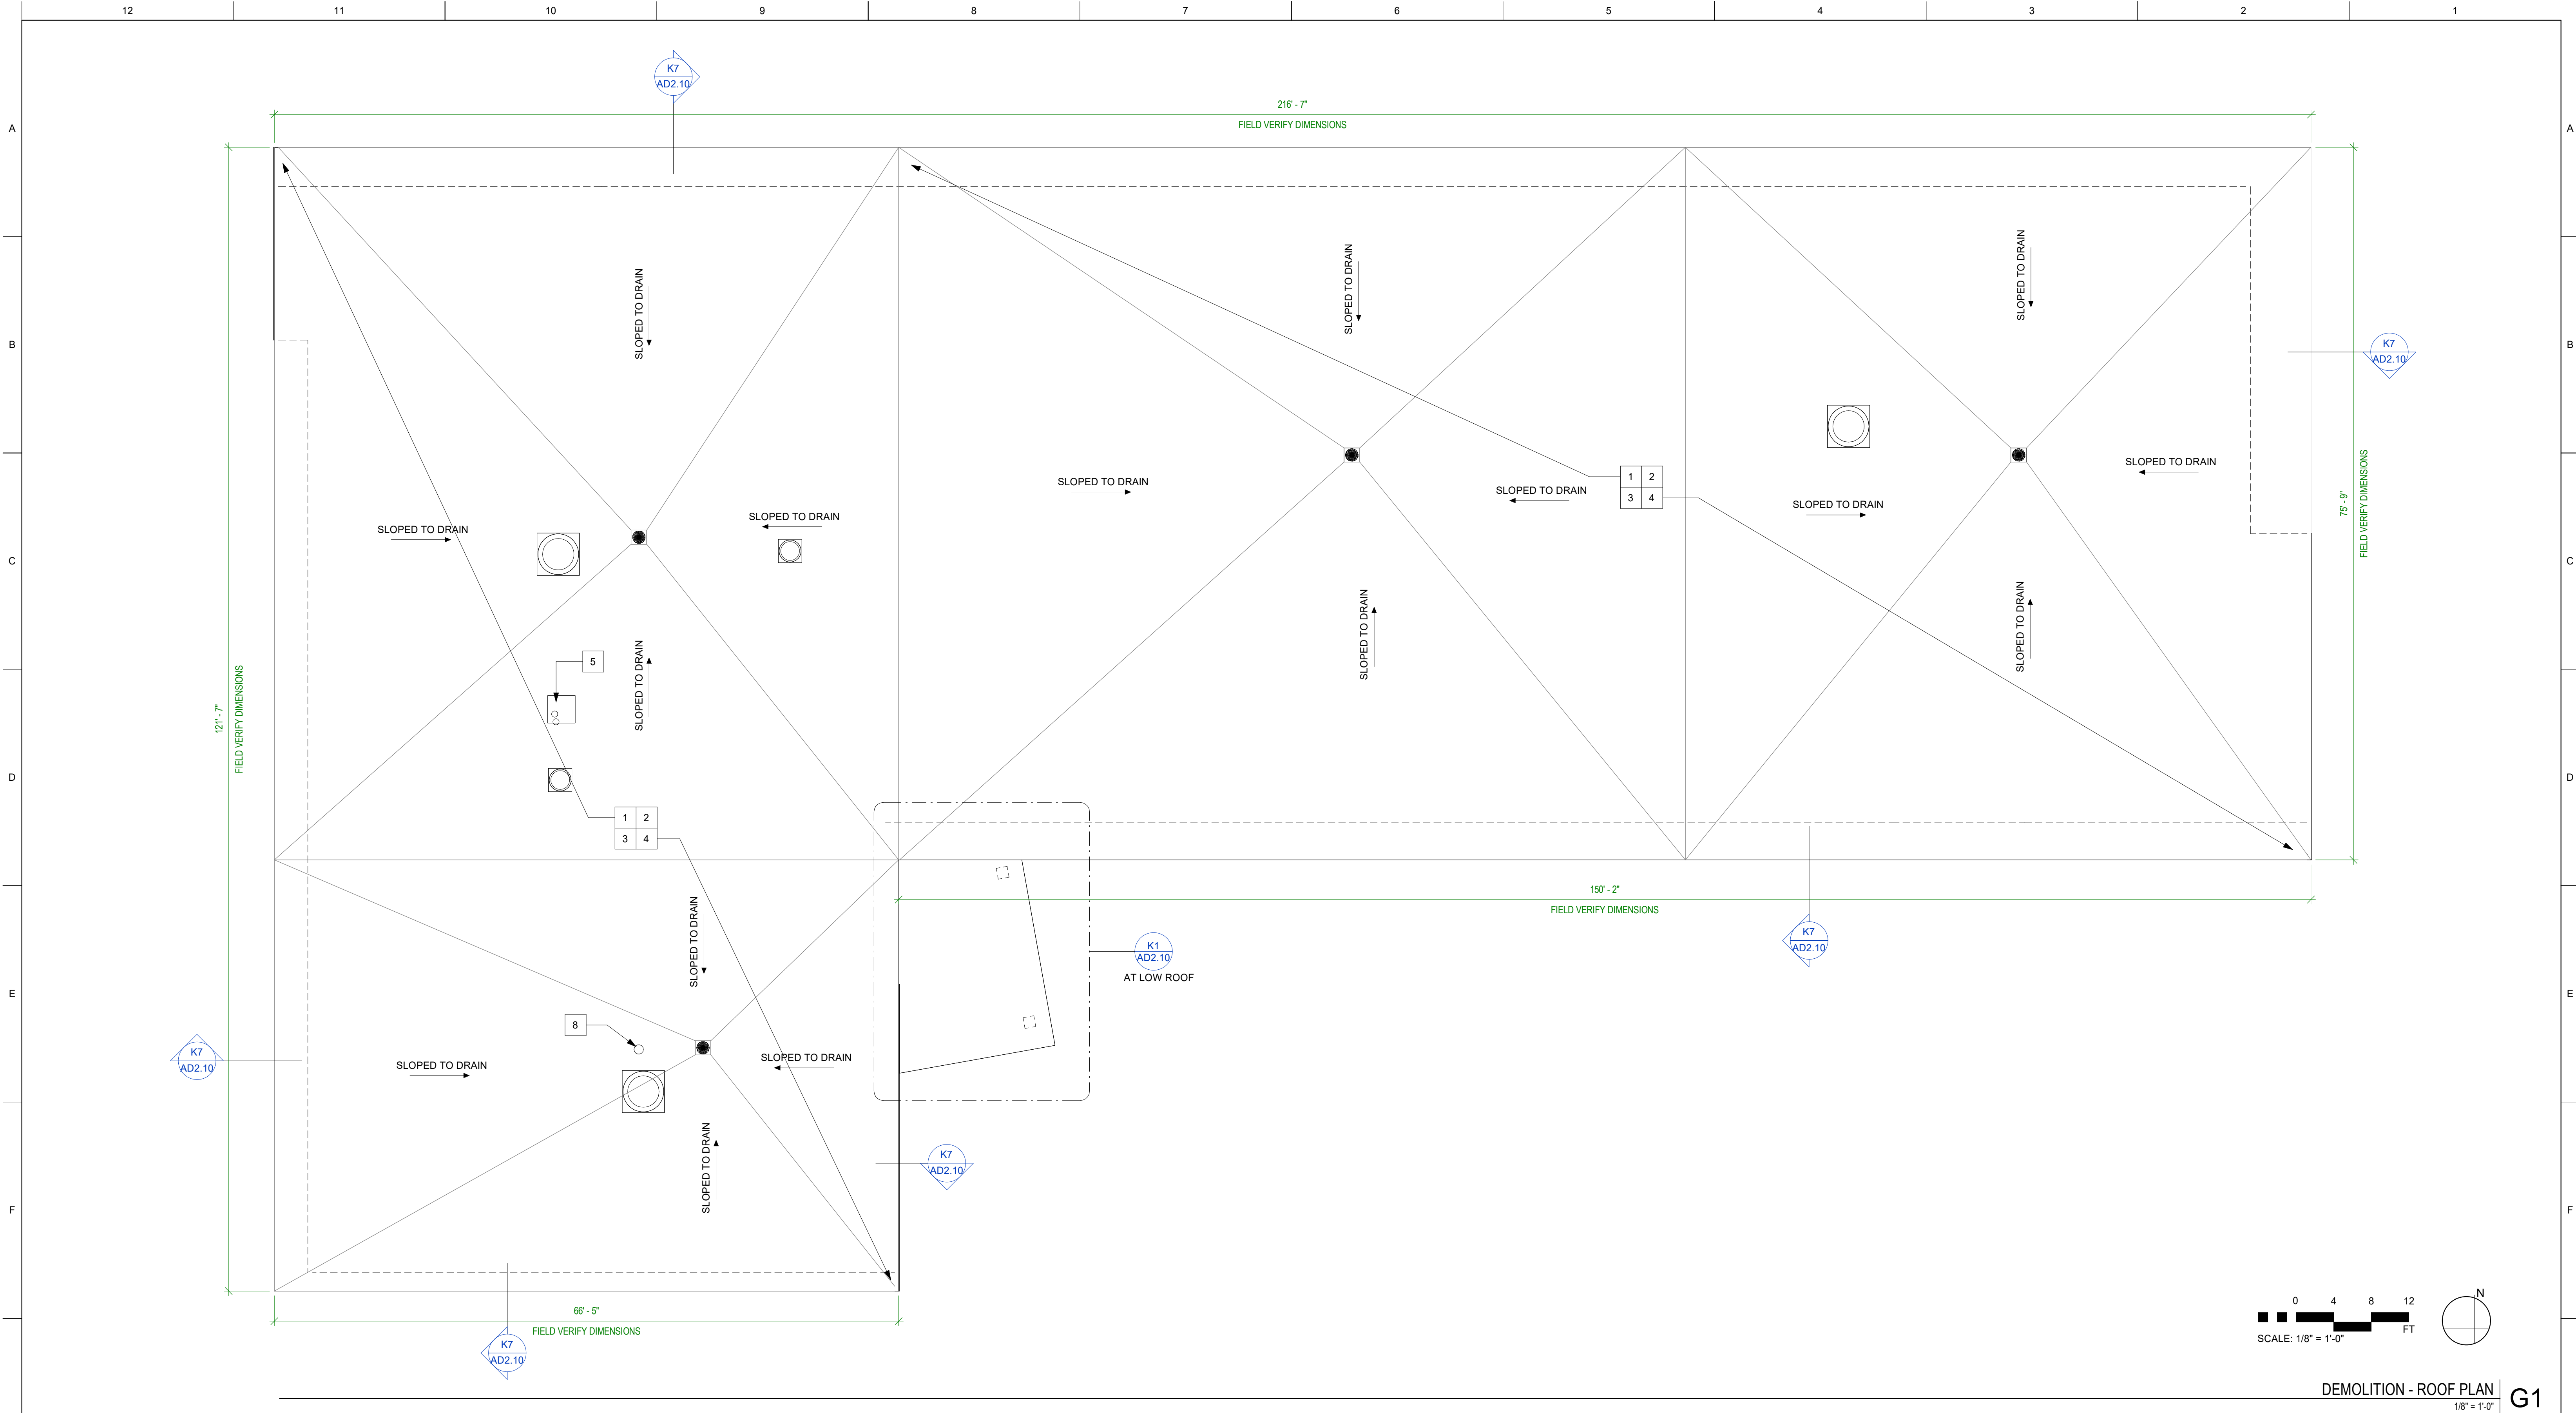


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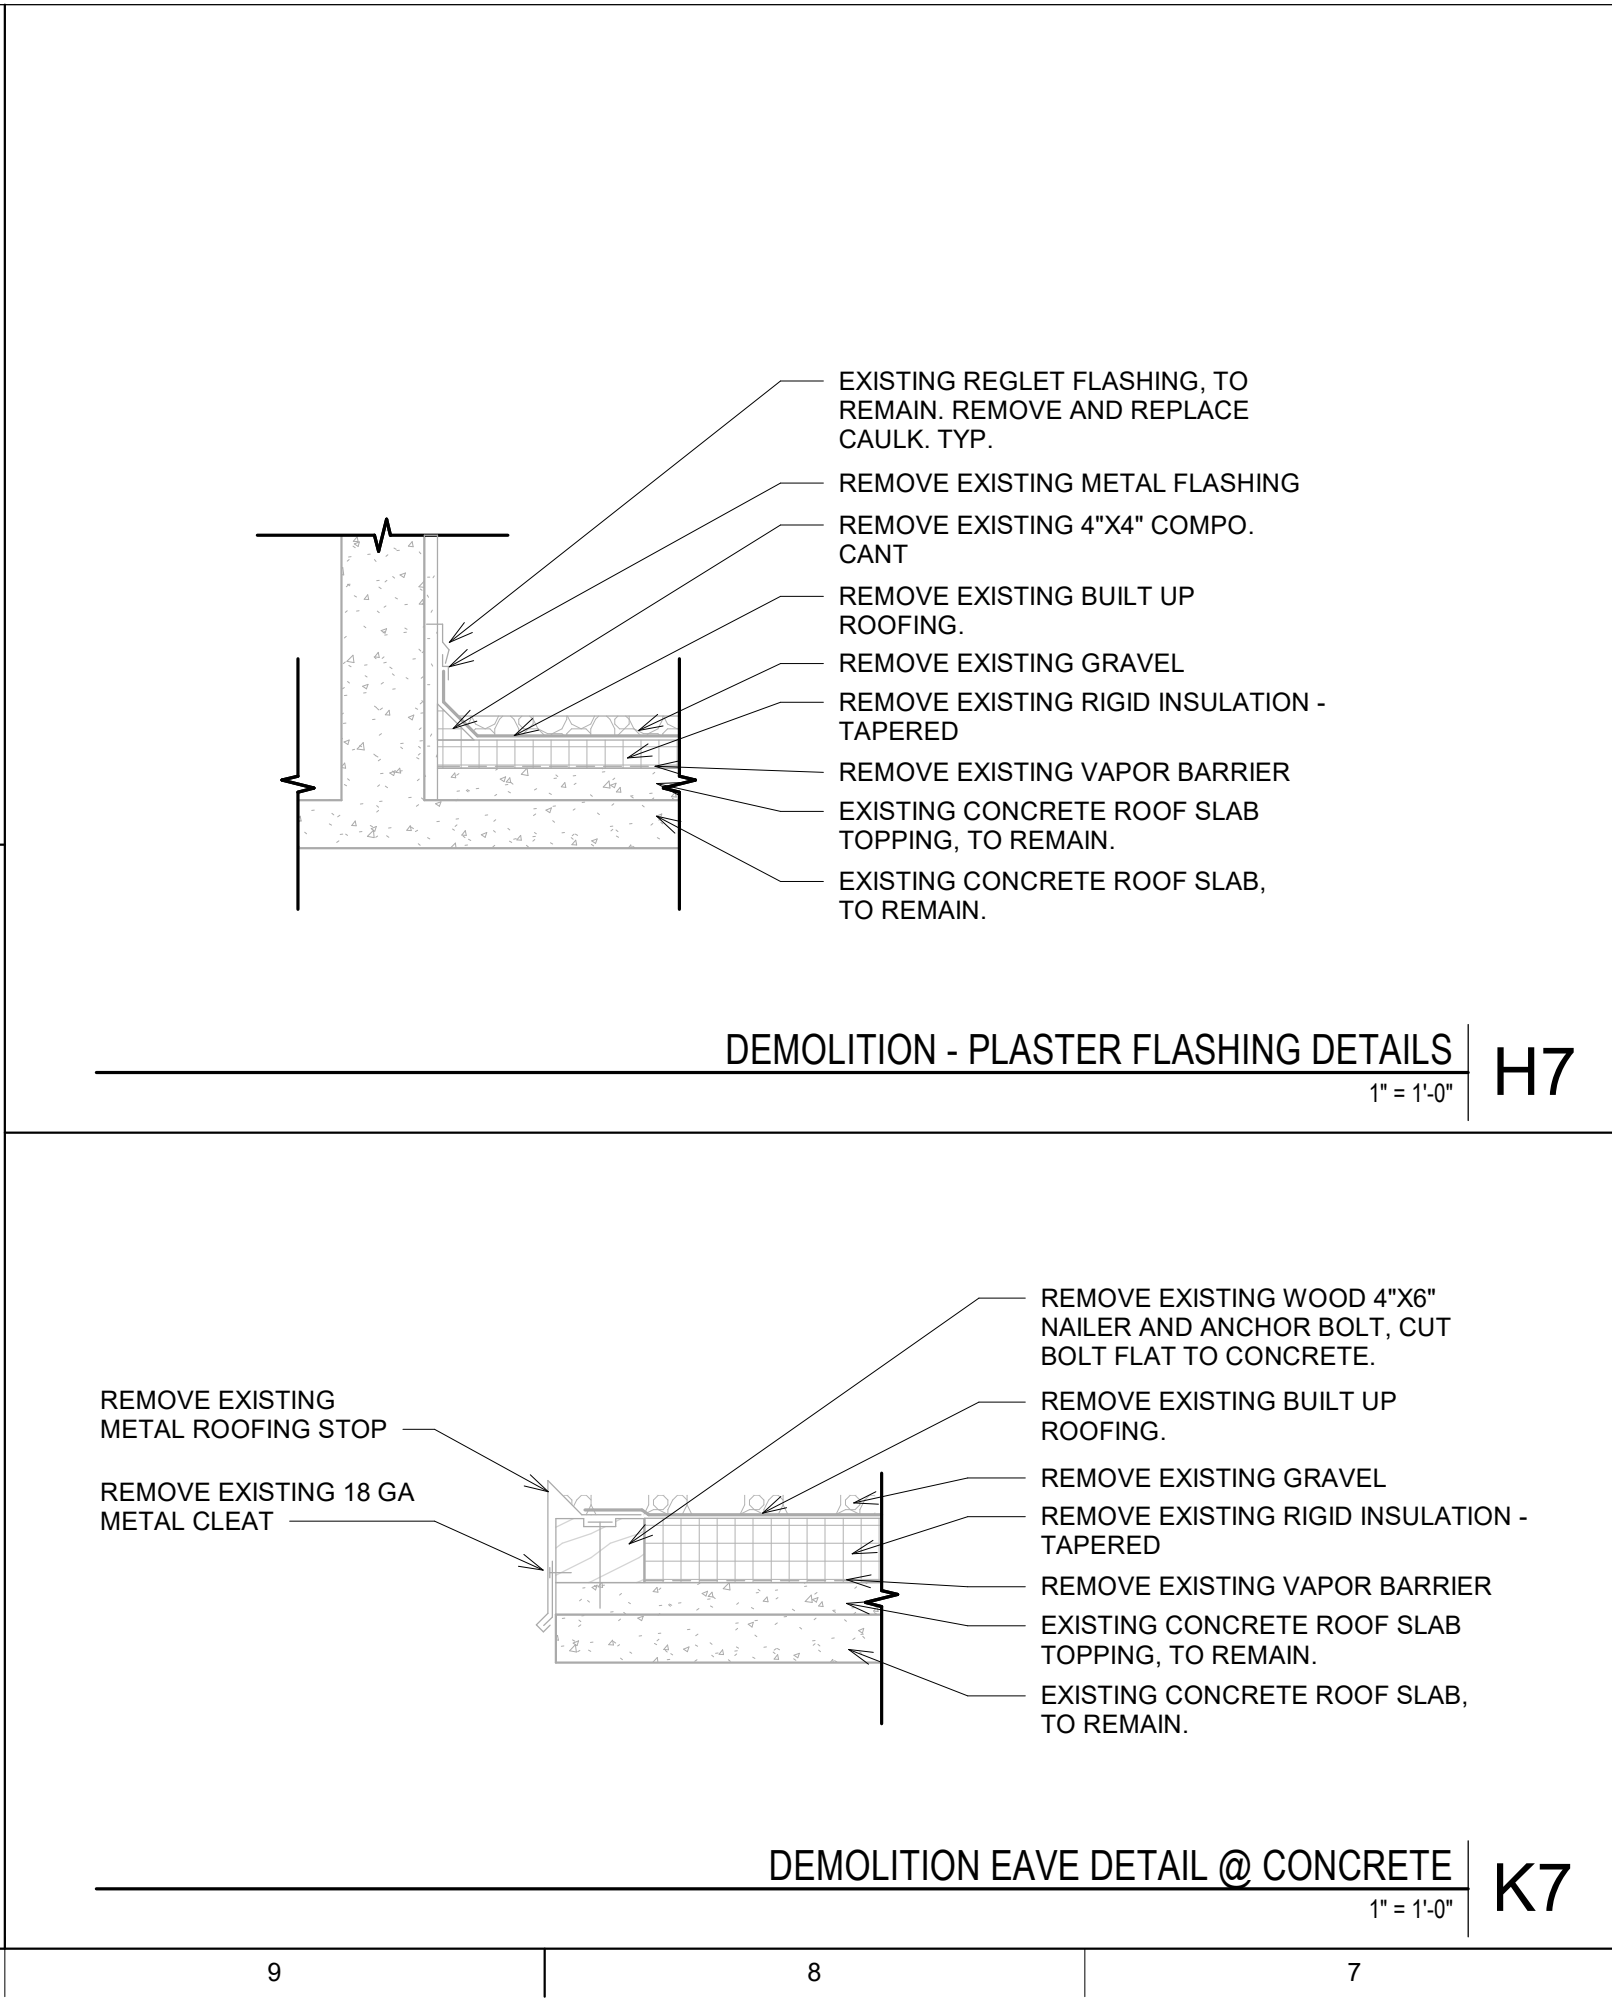
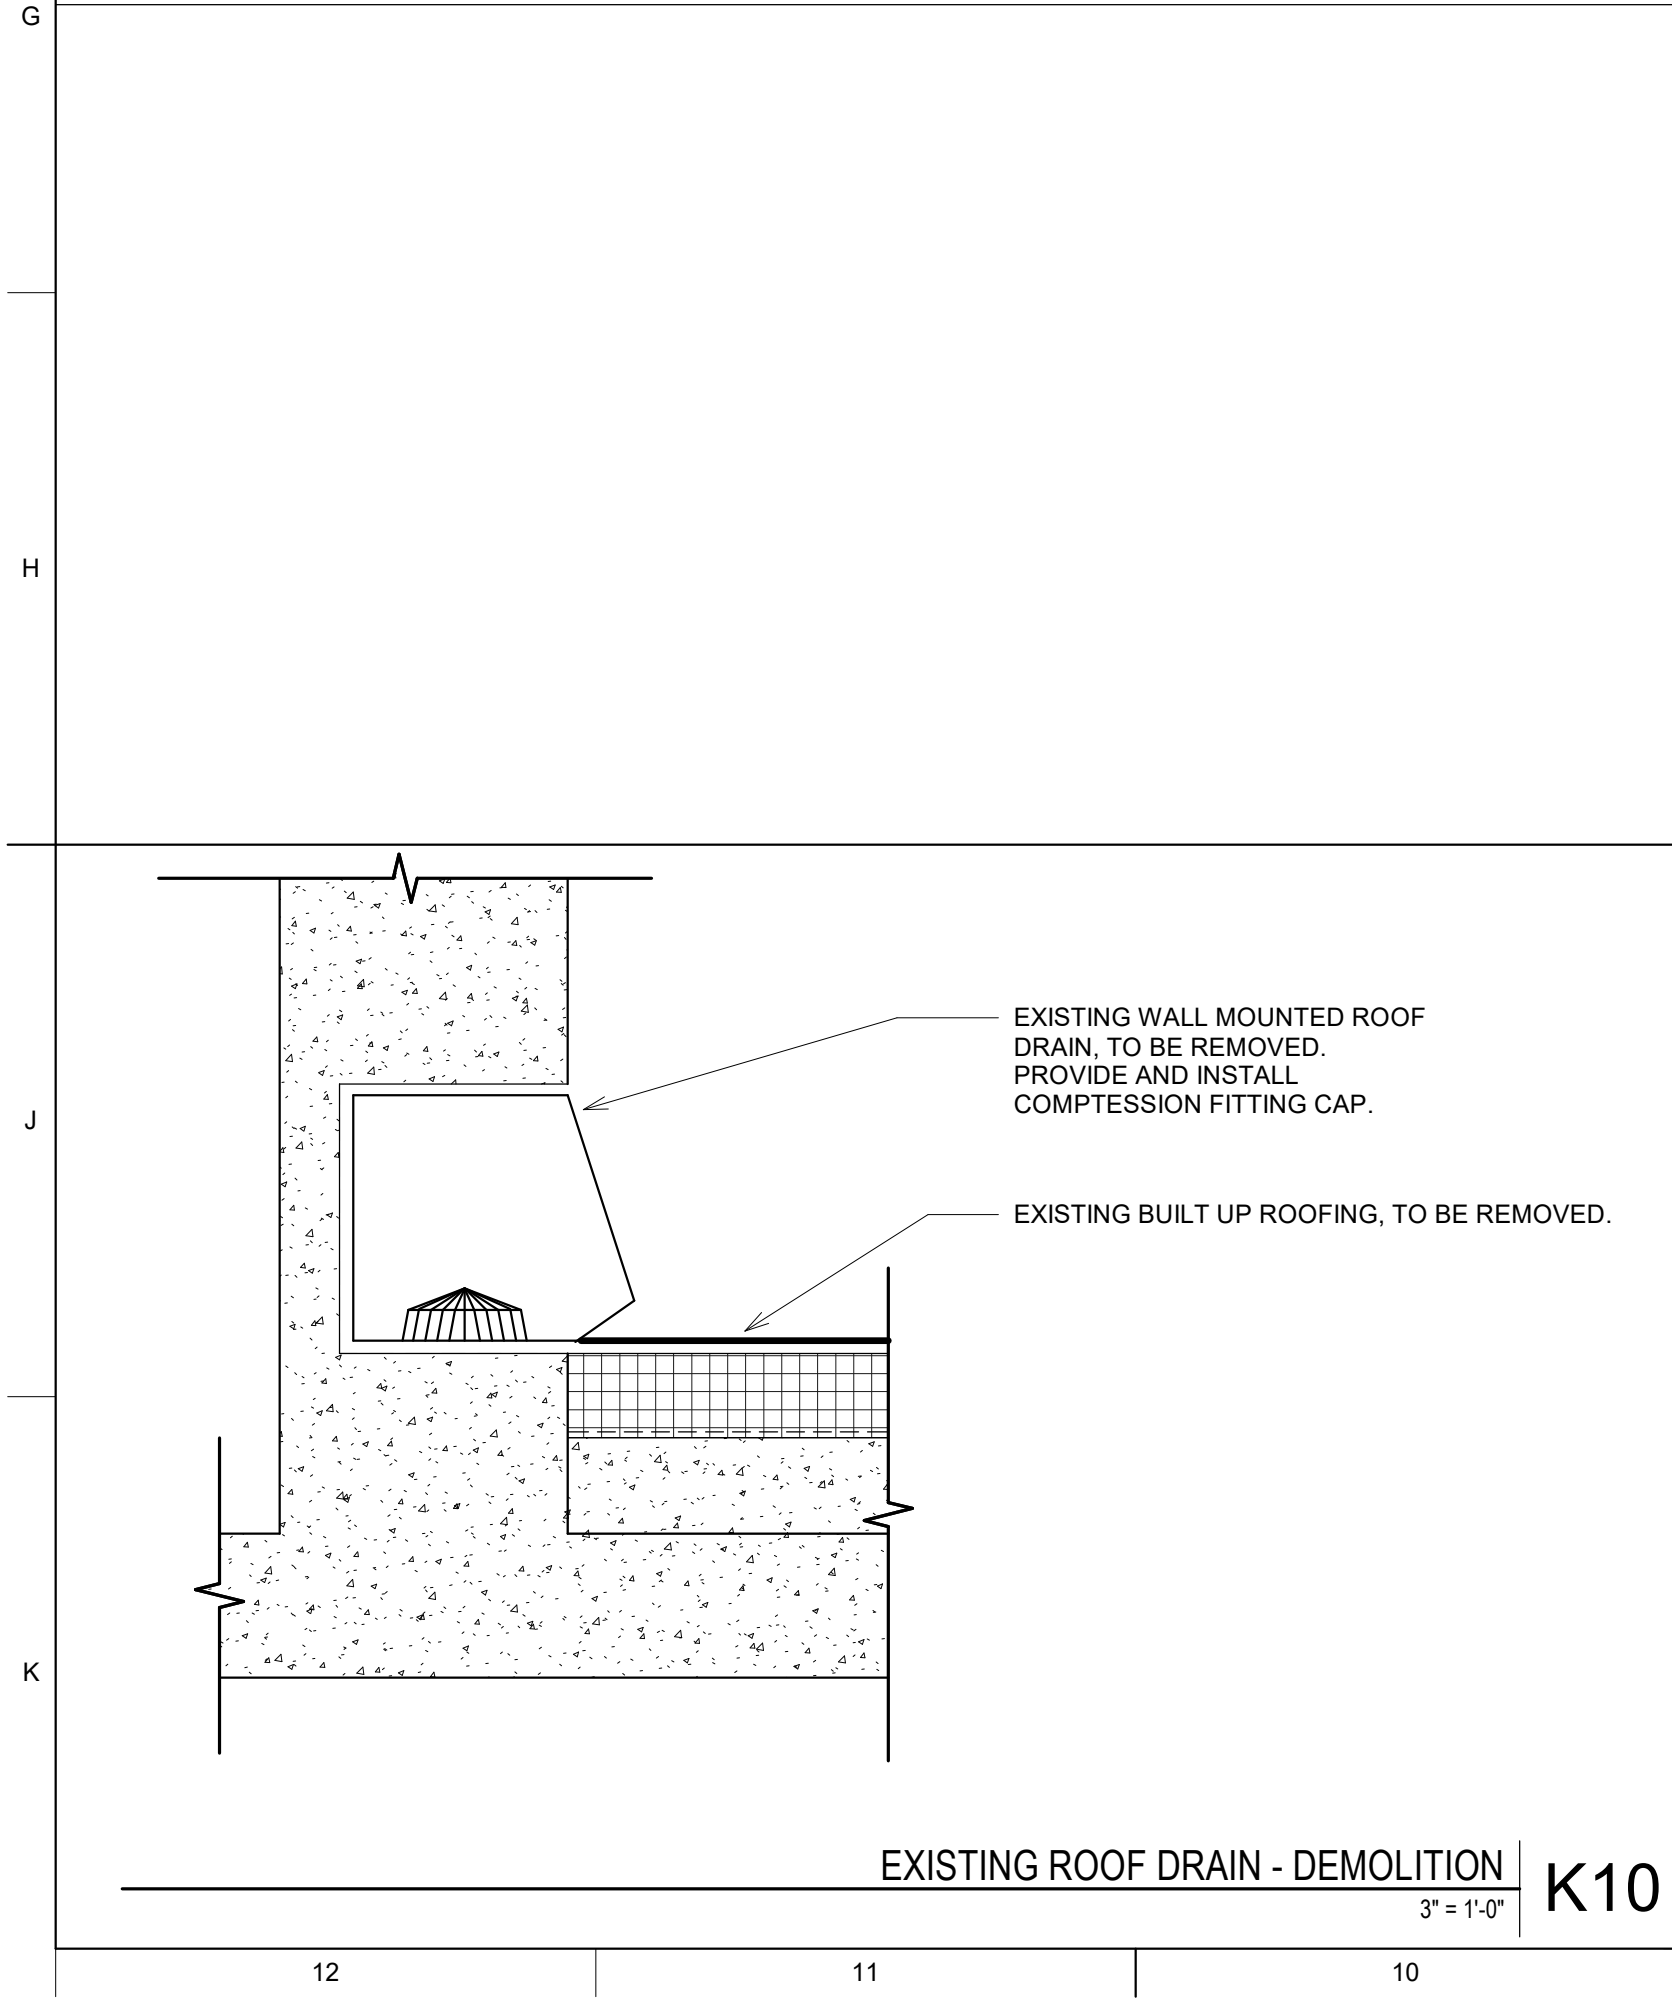
Architecture + Design
723 S Street Suite 150 Sacramento CA 95811 ph 916 443 0335
49 Geary Street Suite 520 San Francisco CA 94108 ph 415 213 0335 LPAS.com
Making Buildings Together

PROJECT NO. 1485-0004

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<div># & (E) (N) @ L Ø A.C. A.C.P. A.D. A.F.F. A.H.J. A.L.S. ACOUS. ADJ. AGGR. ALUM. APPROX. ARCH. ASPH. B.O. B.O.D. BD. BITUM. BLDG. BLK. BLKG. BM. BOT. C.B. C.B.C. C.F.C.I. C.G. C.I. C.I.P. C.J. C.L. C.O. C.W. CAB. CEM. CER. CLG. CLK. CLO. CLR. CNTR. COL. COMP. CONC. CONF. CONN. CONSTR. CONT. CORR. CTR. CTSK. D.F. D.G. D.O. D.S. D.S.P. DBL. DEMO. DEPT. DET. DIA. DIM. DISP. DN. DR. DTL. DWG. DWR. E. E.J. E.O.S. E.F. E.W.C. EA. EL. ELEC. ELEV. EMER. ENCL. EQ. EQPT. EXP. EXPO. EXST. EXT. F.A. F.B. F.D. F.E. F.F. F.H.C. F.O.C. F.O.F. F.O.M. F.O.S. F.S. FDN. FL. FLASH. FLUOR. FPRF. FRMG. FT. FTG. FURR. FUT. G.B. G.S.M. GA. GALV. GL. GND. GR. GYP. H.B. H.C. H.M. HDWD. HDWR. HORIZ. HR. HT. I.D. I.S.A. INSUL. INT. JAN. JT. K.D.</div>																								<div>L.F. LINEAL FOOT LAM. LAMINATE LAV. LAVATORY LKR. LOCKER LT. LIGHT M.H. MANHOLE M.O. MASONRY OPENING MAX. MAXIMUM MECH. MECHANICAL MED. MEDIUM MEMB. MEMBRANE MFR. MANUFACTURER MIN. MINIMUM MIR. MIRROR MISC. MISCELLANEOUS MTD. MOUNTED MTL. METAL MUL. MULLION N. NORTH N.I.C. NOT IN CONTRACT N.R. NON RATED N.T.S. NOT TO SCALE NO. NOM. NOMINAL O.A. OVERALL O.C. ON CENTER O.D. OUTSIDE DIAMETER O.F.C.I. OWNER FURNISHED CONTRACTOR INSTALLED O.F.D. OVERFLOW DRAIN O.F.O.I. OWNER FURNISHED OWNER INSTALLED O.H. OPPOSITE HAND O.S.B. ORIENTED STRAND BOARD O/ OVER OBS. OBSOURE OCC. OCCUPANTS OR OCCUPANCY OFF. OFFICE OPNG. OPENING OPP. OPPOSITE P.L. PROPERTY LINE P.LAM. PLASTIC LAMINATE P.O.T. PATH OF TRAVEL P.T.D. PAPER TOWEL DISPENSER P.T.D.R. PAPER TOWEL DISPENSER/RECEPTACLE P.T.D.F. PRESSURE TREATED DOUGLAS FIR PL. PLATE PLAS. PLASTER PLYWD. PLYWOOD PNTD. PAINTED PR. PAIR PRCST. PRECAST R.C. RESILIENT CHANNEL R.D. ROOF DRAIN R.O. ROUGH OPENING R.R. RESTROOM R.W.L. RAIN WATER LEADER RAD. RADIUS REC. RECESSED RECL. RECYCLING REF. REFERENCE REFR. REFRIGERATOR REINF. REINFORCED REQ. REQUIRED RESIL. RESILIENT RGTR. REGISTER RISER ROOM RWD. REDWOOD S. SOUTH S.A.M. SELF-ADHERED MEMBRANE S.C. SOLID CORE S.C.D. SEAT COVER DISPENSER S.D. SOAP DISPENSER S.F. SQUARE FOOT S.M.S. SHEET METAL SCREW S.N.D. SANITARY NAPKIN DISPENSER S.N.R. SANITARY NAPKIN RECEPTACLE S.O.G. SLAB ON GRADE S.S. STAINLESS STEEL S.SK. SERVICE SINK SCHED. SCHEDULE SECT. SECTION SEP. SEPARATE OR SEPARATION SHT. SHEET SHTG. SHEATHING SHWR. SHOWER SIM. SIMILAR SPEC. SPECIFICATION SQ. SQUARE ST. STATION STD. STANDARD STL. STEEL STR. STRUCTURAL SUSP. SUSPENDED SYM. SYMMETRICAL T. TEMPERED GLASS T&G. TONGUE AND GROOVE T.B. TOWEL BAR T.B.D. TO BE DETERMINED T.O.C. TOP OF CONCRETE T.O.P. TOP OF PARAPET T.O.S.F. TOP OF SUB-FLOOR T.O.STL. TOP OF STEEL T.O.W. TOP OF WALL T.P. TOP OF PAVEMENT T.P.D. TOILET PAPER DISPENSER TEL. TELEPHONE TER. TERRAZZO THK. THICK TRNS. TRANSITION TRD. TREAD TYP. TYPICAL U.O.N. UNLESS OTHERWISE NOTED UNF. UNFINISHED UR. URINAL UTIL. UTILITY V.I.F. VERIFY IN FIELD VERT. VERTICAL VEST. VESTIBULE W. WEST W.C. WATER CLOSET W.O. WHERE OCCURS W.P. WATERPROOF W.R.B. WEATHER RESISTIVE BARRIER W.V. WOOD VENEER W/ WITH W/O WITHOUT WD. WOOD WSCOT. WAINSCOT WT. WEIGHT</div>																								<div>FLOW LINE NEW CONTOUR EXISTING CONTOUR CENTERLINE PROPERTY LINE PROJECTED LINE HIDDEN LINE BREAK LINE MATCH LINE CONTRACT LIMIT LINE LEVEL 12'-0" ELEVATION MARK OR DATUM POINT WALL TYPE LOCATION USED: T=INTERIOR, E=EXTERIOR MATERIAL: W=WOOD, S=STEEL FIRE RATING: 1HR, 2HR, 3HR IDENTIFIER: NUMBER DESIGNATION STC RATING REVISION CLOUD WITH DELTA # GRID LINES NORTH ARROW OFFICE 155 ROOM NAME AND NUMBER DOOR NUMBER WINDOW TYPE KEYNOTE SPECIFICATION SECTION IDENTIFICATION IDENTIFIER: NUMBER DESIGNATION SECTION SECTION IDENTIFICATION SHEET WHERE SECTION IS DRAWN DETAIL DETAIL IDENTIFICATION SHEET WHERE DETAIL IS DRAWN INTERIOR ELEVATION ELEVATION IDENTIFICATION SHEET WHERE ELEVATION IS DRAWN ALIGN ALIGN FINISH SURFACES</div> <div>1. PROJECT SHALL COMPLY WITH THE LOCALLY ADOPTED CODES AS NOTED IN APPLICABLE CODES. THIS SHEET, THE CONTRACTOR SHALL CONFINE OPERATIONS ON THE SITE TO AREAS PERMITTED BY THE OWNER. THE WORK SHALL BE DONE IN ACCORDANCE WITH APPLICABLE LAWS, LOCAL ORDINANCES, PERMITS, AND THE CONTRACT DOCUMENTS. THE JOB SITE SHALL BE MAINTAINED IN A CLEAN, ORDERLY CONDITION, FREE OF DEBRIS AND LITTER, AND SHALL NOT BE UNREASONABLY ENCUMBERED WITH ANY MATERIALS OR EQUIPMENT. EACH SUB-CONTRACTOR, IMMEDIATELY UPON COMPLETION OF WORK, SHALL REMOVE ALL TRASH AND DEBRIS AS A RESULT OF OPERATIONS. CONTRACTOR SHALL VERIFY ALL CONDITIONS AND DIMENSIONS ON SITE PRIOR TO STARTING CONSTRUCTION. SHOULD A DISCREPANCY APPEAR IN THE SPECIFICATIONS OR DRAWINGS, OR IN THE WORK DONE BY OTHERS FROM THE CONTRACT DOCUMENTS THAT AFFECT ANY WORK, NOTIFY THE ARCHITECT AT ONCE FOR INSTRUCTION ON HOW TO PROCEED. IF THE CONTRACTOR PROCEEDS WITH THE WORK AFFECTED WITHOUT INSTRUCTIONS FROM THE ARCHITECT, THE CONTRACTOR SHALL MAKE GOOD ANY RESULTING DAMAGE OR DEFECT TO THE SATISFACTION OF THE ARCHITECT.</div> <div>2. SHOULD A CONFLICT OCCUR IN OR BETWEEN DRAWINGS AND SPECIFICATIONS, OR WHERE DETAIL REFERENCES ON CONTRACT DRAWINGS HAVE BEEN OMITTED, THE CONTRACTOR IS DEEMED TO HAVE ESTIMATED THE MOST EXPENSIVE MATERIALS AND CONSTRUCTION METHOD INVOLVED, UNLESS A WRITTEN DECISION FROM THE ARCHITECT HAS BEEN OBTAINED WHICH DESCRIBES AN ALTERNATE METHOD AND/OR MATERIALS.</div> <div>3. CONTRACTOR SHALL NOTIFY THE ARCHITECT WHERE A CONFLICT OCCURS ON ANY OF THE CONTRACT DOCUMENTS OR DRAWINGS. CONTRACTOR IS NOT TO ORDER MATERIAL OR CONSTRUCT ANY PORTION OF THE BUILDING THAT IS IN CONFLICT UNTIL CONFLICT IS RESOLVED WITH THE AFFECTED PARTIES. NOTIFICATION SHALL BE MADE SO AS TO NOT DELAY THE PROJECT CRITICAL PATH.</div> <div>4. EXIT DOORS SHALL BE OPENABLE FROM THE INSIDE WITHOUT THE USE OF A KEY OR SPECIAL KNOWLEDGE OR EFFORT. EXIT SIGNS SHALL BE PROVIDED AT ALL EXITS AS REQUIRED BY CODE. ALL DOOR SWINGS SERVING AN OCCUPANT LOAD OF 50 OR GREATER SHALL SWING IN THE DIRECTION OF EXIT.</div> <div>5. PROVIDE ILLUMINATED EXIT SIGNS PER THE REQUIREMENTS OF THE CALIFORNIA BUILDING CODE.</div> <div>6. PROVIDE FIRE EXTINGUISHERS PER THE REQUIREMENTS OF THE AUTHORITY HAVING JURISDICTION.</div> <div>7. CONSTRUCTION SHALL COMPLY WITH THE AIR LEAKAGE REQUIREMENTS OF THE CALIFORNIA ADMINISTRATIVE CODE FOR WINDOWS, DOORS, CAULKING AND SEALING, ELEVATOR SHAFT VENTS AND ALL OTHER APPLICABLE REQUIREMENTS.</div> <div>8. ALL WATERPROOFING SHALL BE FROM A SINGLE SOURCE MANUFACTURER.</div> <div>9. JOINT SEALERS SHALL BE REQUIRED AT THE INTERSECTION OF ALL DISSIMILAR MATERIALS AT INTERIOR AND EXTERIOR CONDITIONS. ARCHITECTURAL, MECHANICAL AND ELECTRICAL PENETRATIONS OF THE BUILDING ENVELOPE INCLUDING EXTERIOR WINDOWS, GRILLES, HVAC DUCTWORK AND CONDUIT AS REQUIRED THROUGH THE EXTERIOR WALLS, ROOF DECKS, VERTICAL ROOF SHALL REQUIRE MECHANICAL FLASHING IN ADDITION TO APPROPRIATE EXTERIOR SEALANTS TO ENSURE WATERTIGHT CONDITIONS AT THESE LOCATIONS.</div> <div>10. ALL EXTERIOR LOUVERED GRILLES SHALL BE FACTORY PAINTED WITH KYNAR FINISH TO MATCH THE EXTERIOR FIELD COLOR IN WHICH THEY ARE LOCATED.</div> <div>11. EXTERIOR METALS SHALL BE GALVANIZED OR FIELD PAINTED PER ARCHITECT COORDINATION. GENERAL CONTRACTOR SHALL ASSUME THE MOST STRINGENT FINISH IF NOT INDICATED ON DOCUMENTS.</div> <div>12. UNLESS QUALIFIED AND APPROVED BY OWNER AND ARCHITECT, NO PRODUCT SUBSTITUTIONS OR "OR EQUAL" PRODUCTS, EQUIPMENT OR MATERIALS SHALL BE ALLOWED.</div> <div>13. DIMENSION RULES: A. NOTED DIMENSIONS SHALL AT ALL TIMES TAKE PRECEDENCE OVER SCALED DIMENSIONS. B. ALL DIMENSIONS OF NEW WORK ARE TO THE FACE OF STUD U.O.N. C. ALL DIMENSIONS OF EXISTING WORK ARE TO FACE OF FINISH U.O.N. D. CEILING HEIGHT DIMENSIONS ARE FROM TOP OF FINISHED FLOOR TO FINISH FACE OF CEILING. E. DIMENSIONS NOTED "CLEAR OR "CLR" INDICATE THE MINIMUM DISTANCE REQUIRED BETWEEN FINISHED SURFACES. F. DIMENSIONS ARE NOT ADJUSTABLE WITHOUT APPROVAL OF THE ARCHITECT. G. VERTICAL DIMENSION ARE FROM THE TOP OF THE FLOOR SLAB DATUM LINE, ESTABLISHED BY THE CONTRACTOR SUBJECT TO THE APPROVAL OF THE OWNER OR ARCHITECT, UNLESS OTHERWISE NOTED. H. DIMENSIONS MARKED "A.F.F." ARE ABOVE TOP OF SLAB OR TOP OF SUBSTRATE WHERE NO SLAB OCCURS. I. DIMENSIONS MARKED "V.I.F." SHALL BE "VERIFIED" IN THE FIELD BY THE CONTRACTOR OR SUBCONTRACTOR. J. DIMENSION LOCATING DOORS ARE TO THE INSIDE EDGE OF JAMB, U.O.N.</div>																								<div>OWNER CAL POLY HUMBOLDT FACILITIES MANAGEMENT 1 HARPST STREET, ARCATE, CA 95521 PH. (707) 826-3646</div> <div>ARCHITECT LPAS (SACRAMENTO) 723 S STREET, SUIT 150 SACRAMENTO, CA 95811 PH. (916) 443-0335</div>																								<div>PROJECT NAME: CAL POLY HUMBOLDT SIEMANS HALL PROJECT LOCATION: B STREET ST ARCATA, CA 95521 CSFM #: 18-12-11-0001-00046 OCCUPANCY GROUPS AND VARIED USES: B, A-3, S-1 BUILDING CONSTRUCTION TYPE: IIIB NUMBER OF STORIES: 2 OCCUPANT LOAD FOR BUILDING: 1,678 OCCUPANT LOAD PER FLOOR: YEAR BUILDING WAS CONSTRUCTED: 1958 HIGH FIRE HAZARD SEVERITY ZONE: NO SEISMIC JOINTS AND LOCATIONS: NO EMERGENCY RESPONDER RATIO COVERAGE: NO ZONING DISTRICT: LOT AREA: PROPOSED ROOF ASSEMBY: CLASS A.</div> <div>BASEMENT: FLOOR 1: 418 OCCUPANTS FLOOR 2: 120 OCCUPANTS TOTAL: 571 OCCUPANTS FLOOR 1: 16,785 SQ FT FLOOR 2: 16,785 SQ FT TOTAL: 33,570 SQ FT</div>																								<div>GOVMOTUS NUMBER -- XXXXXXXXXXXX</div> <div>LPAS</div> <div>Architecture + Design 723 S Street Suite 150 Sacramento CA 95811 916.443.0335 ph 10 Clay Street Suite 250 Oakland CA 94607 415.213.0335 ph LPAS.com</div> <div>CAL POLY HUMBOLDT SIEMENS HALL ROOF REPLACEMENT 1 HARPST ST ARCATE, CA 95521</div> <div><table><thead><tr><th>NO.</th><th>ISSUE</th><th>DATE</th></tr></thead><tbody><tr><td colspan="3"> </td></tr><tr><td colspan="3"> </td></tr><tr><td colspan="3"> 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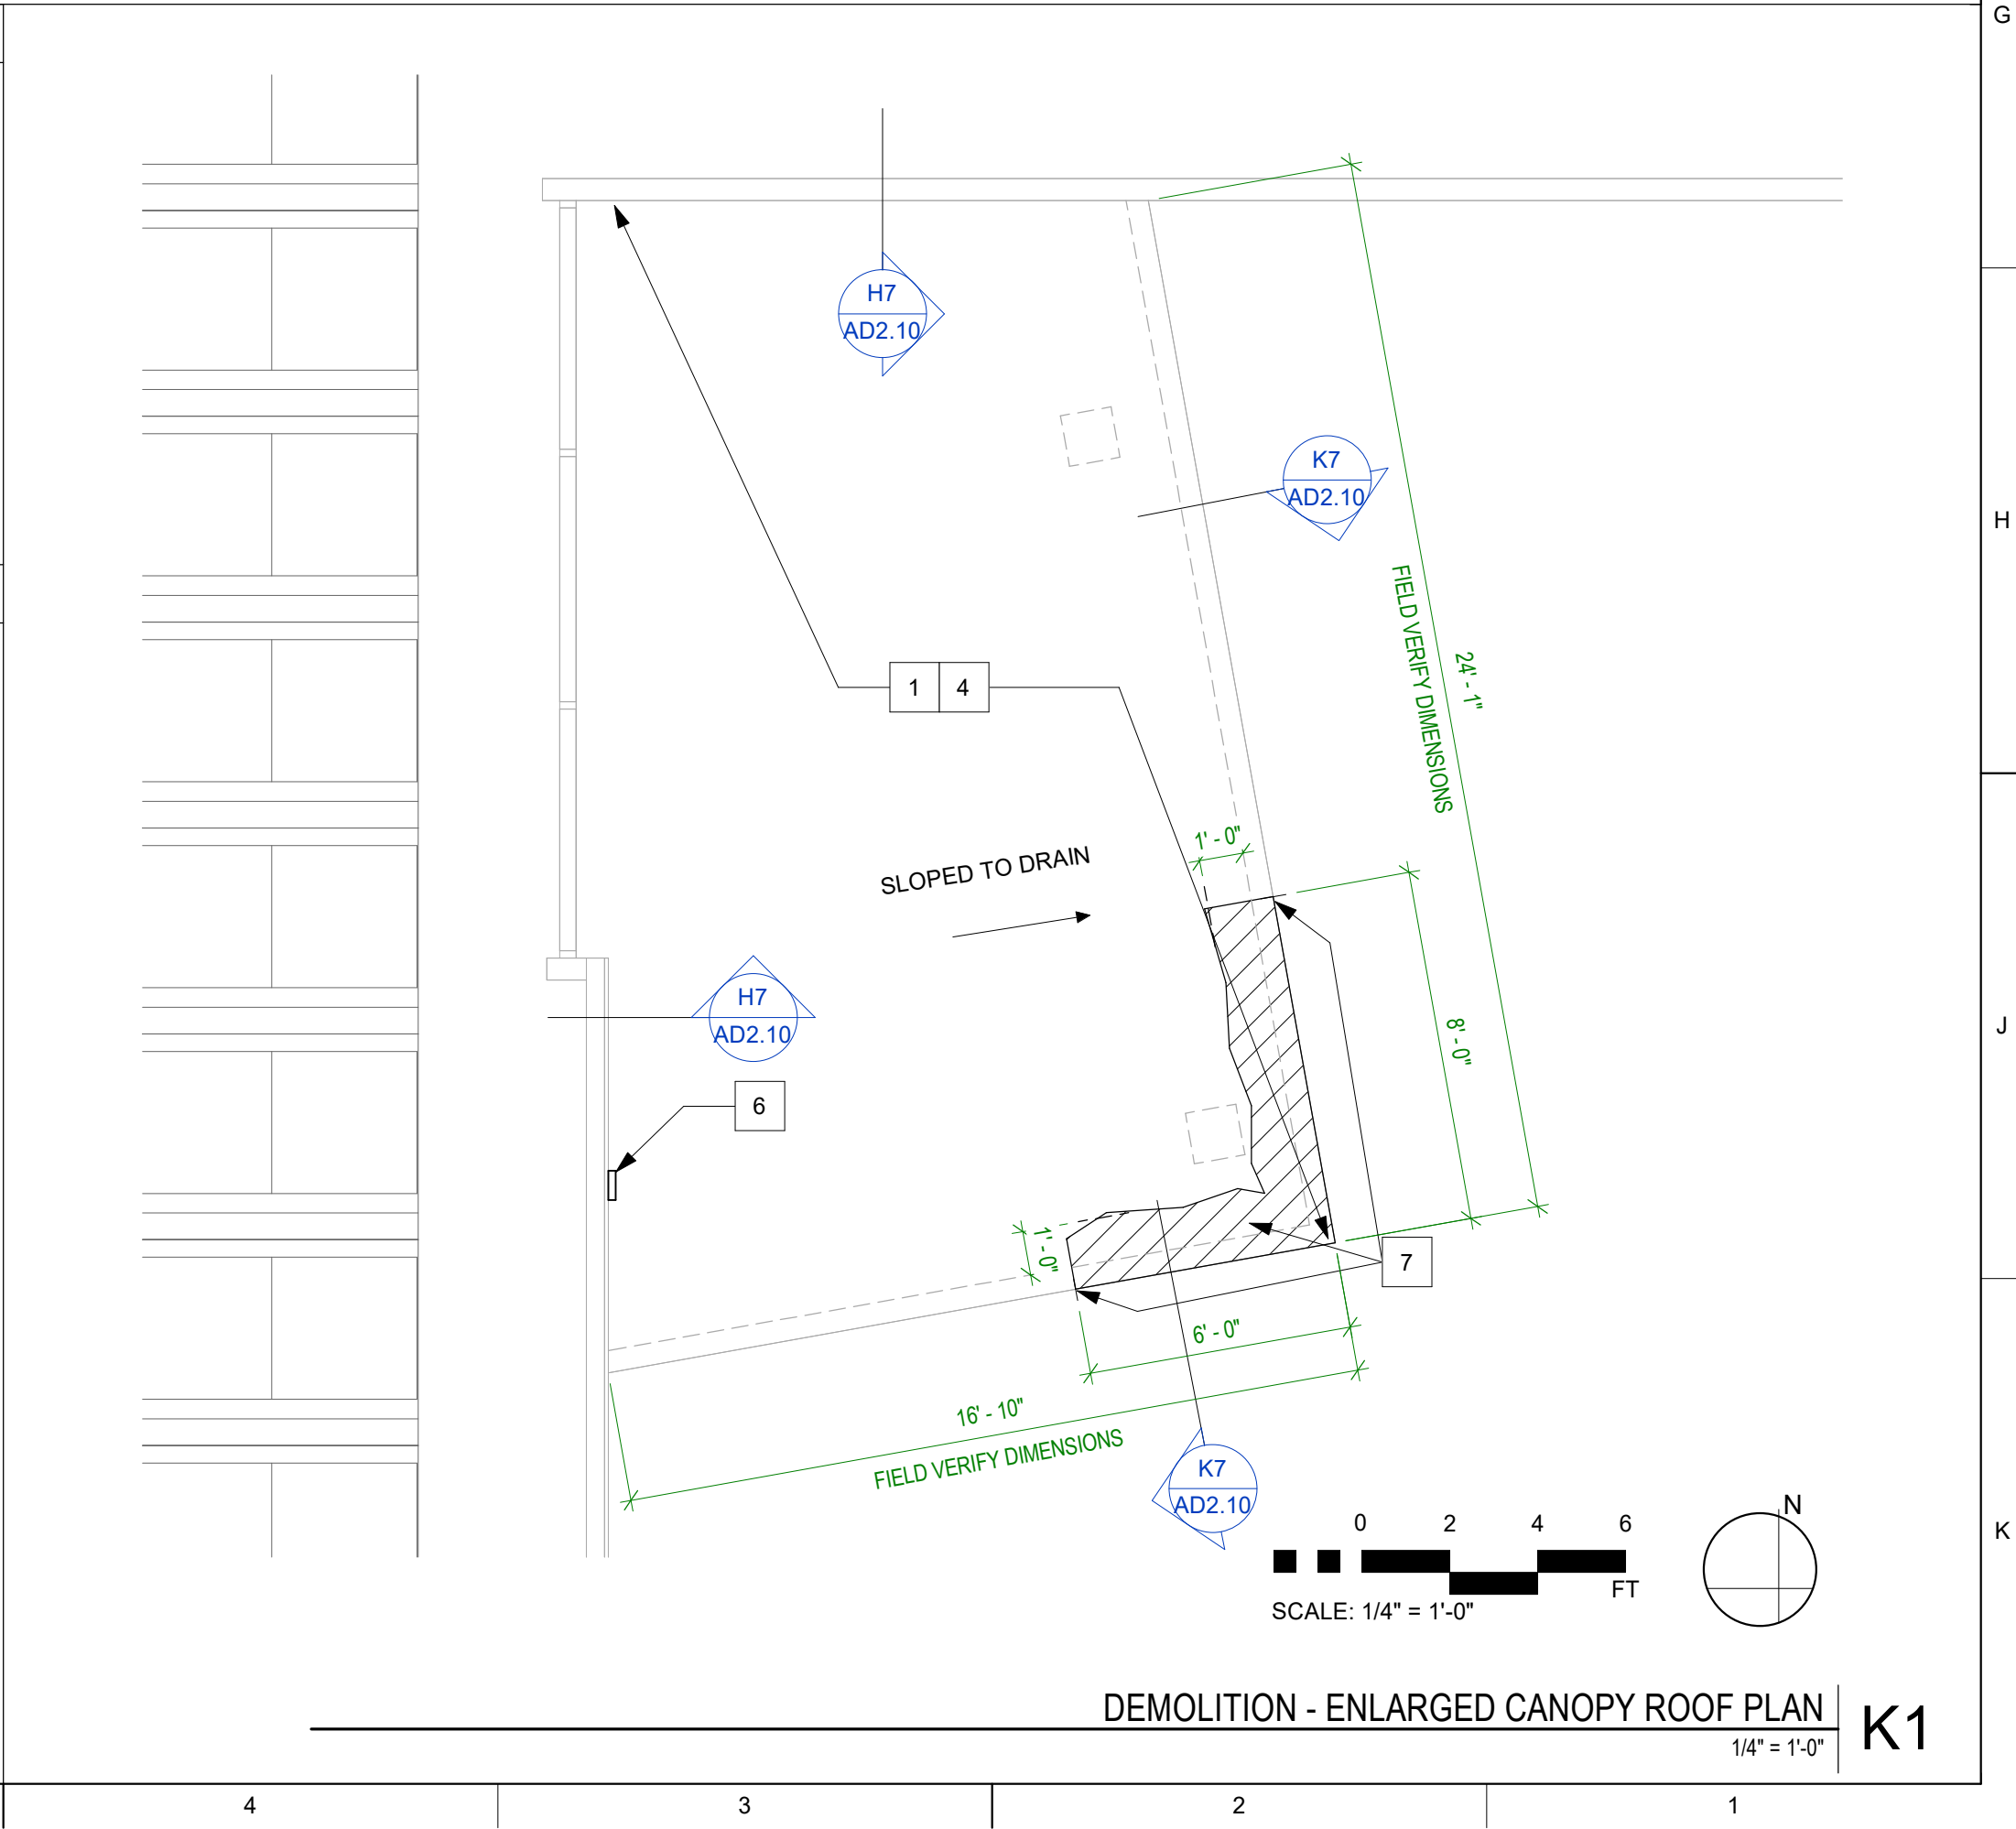


DEMOLITION - ROOF PLAN | 1/8" = 1'-0" | G1



DEMOLITION ROOF PLAN LEGEND	
	EXISTING WALL OR OBJECT TO REMAIN
	EXISTING WALL OR OBJECT TO BE DEMOLISHED
	EXISTING ROOF DRAIN
	EXISTING EXHAUST FAN

DEMOLITION ROOF PLAN KEYNOTE LEGEND	
1	EXISTING GRAVEL, BUILT UP ROOFING, RIGID INSULATION, VAPOR BARRIER AND FLASHING TO BE REMOVED, TYP OF ENTIRE BUILDING
2	EXISTING ROOF MOUNTED EXHAUST FAN AND CURB TO BE REMOVED. SALVAGE UNIT FOR REINSTALLATION IN SAME LOCATION, TYP OF ALL UNITS. REINSTALLATION INCLUDES ELECTRICAL CONNECTIONS AND CONTROLS.
3	EXISTING VENT FLASHING TO BE REMOVED, TYP OF ALL VENTS. REFER TO OWNER PROVIDED HAZARDOUS MATERIALS REPORT FOR ADDITIONAL INFORMATION.
4	EXISTING ROOF DRAIN TO BE REMOVED, TYP OF ALL DRAINS
5	EXISTING CONCRETE CURB, METAL CAP, AND EXHAUST FLUE TO REMOVE.
6	EXISTING WALL MOUNTED ROOF DRAIN, TO BE REMOVED. REMOVE SECTIONS OF EXISTING CEMENT WALL AS REQUIRED TO PROVIDE ACCESS. SEE DETAIL K10/AD2.1
7	REMOVED SECTIONS OF EXISTING CEMENT PLASTER AND ACCESSORIES. AT SOFFIT FACE AND SOFFIT CEILING.
8	EXISTING VENT AND VENT FLASHING TO BE REMOVED.



DEMOLITION - ENLARGED CANOPY ROOF PLAN | 1/4" = 1'-0" | K1

GOVMOTUS NUMBER -- XXXXXXXXXX

LPAS

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CAL POLY HUMBOLDT
SIEMENS HALL

ROOF REPLACEMENT

1 HARPST ST
ARCATE, CA 95521

NO. ISSUE DATE



ARCHITECT'S STAMP APPROVAL

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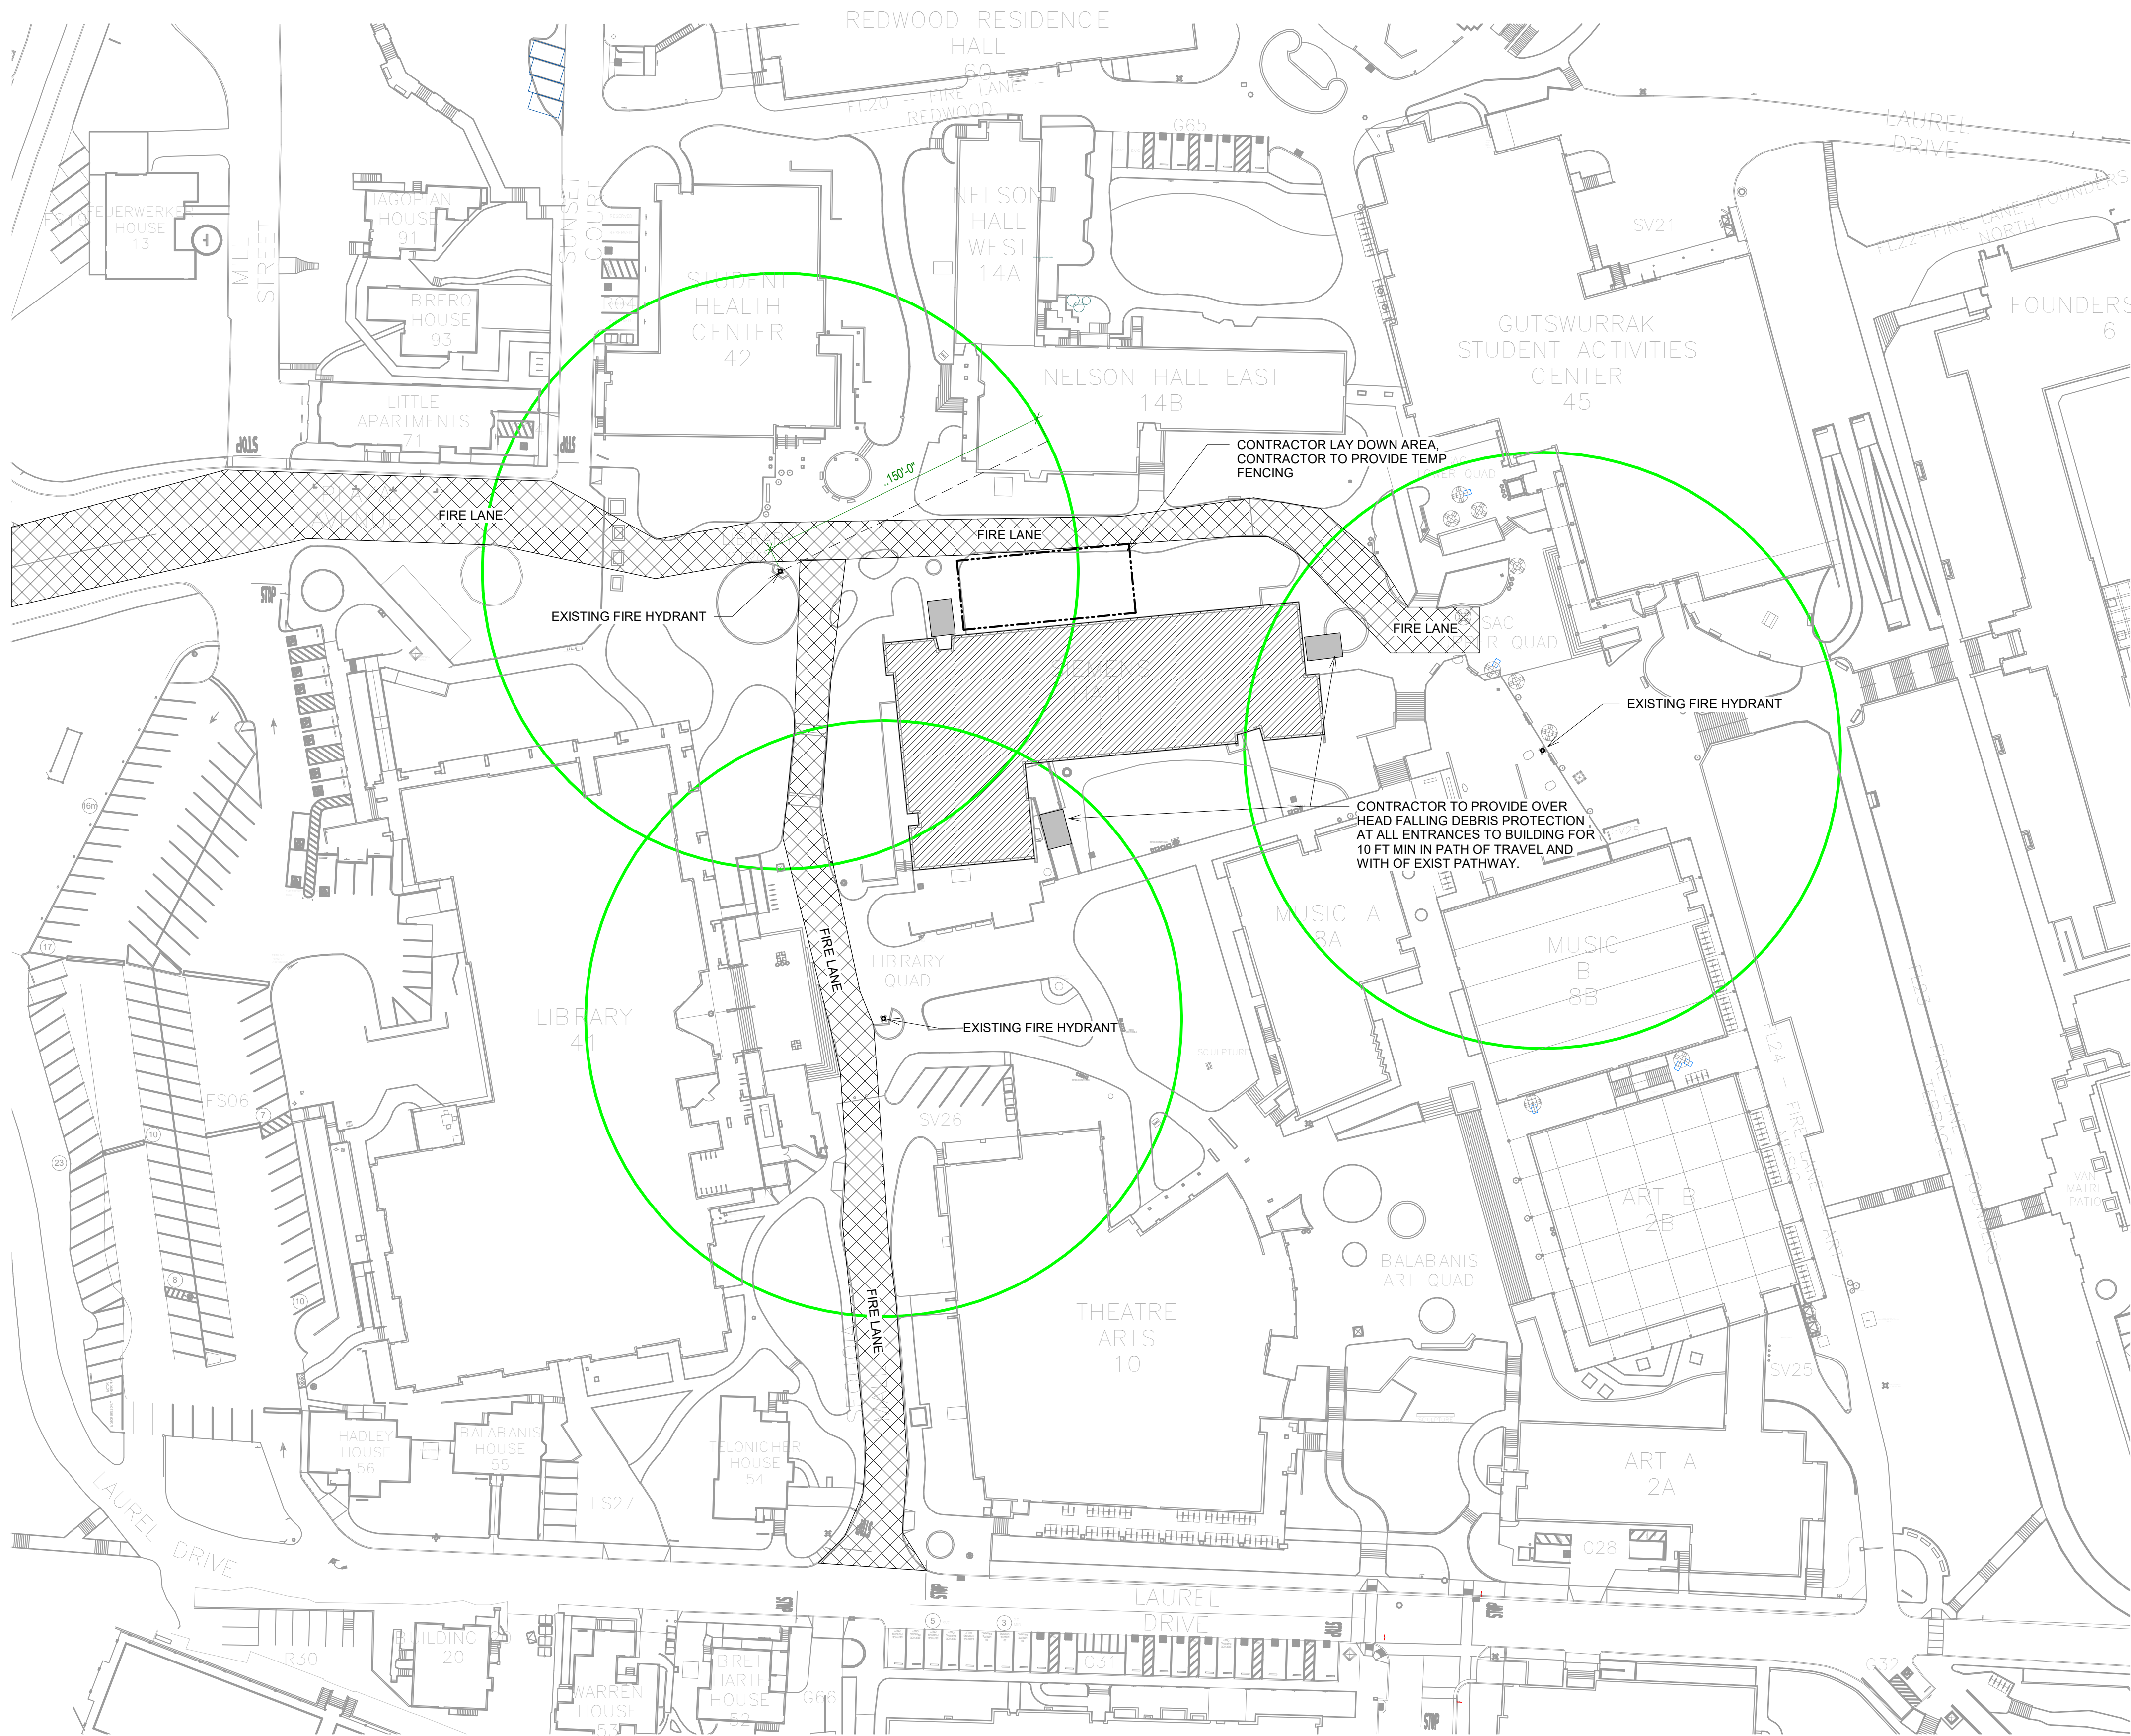
CONSULTANT

DEMOLITION ROOF
PLAN

PROJECT NO: 1485-0004
DATE: 03/27/2025

SHEET NO:

AD2.10



SITE LOGISTICS AND SAFETY PLAN
N.T.S. H3

STATE OF CALIFORNIA – NATURAL RESOURCES AGENCY

DEPARTMENT OF FORESTRY AND FIRE PROTECTION
Office of the State Fire Marshal
P.O. BOX 90000 SACRAMENTO, CA 95834-2000 (916) 568-3801
WWW.CALFIRE.CA.GOV

GOV. NEWSOM, Governor

LOCAL FIRE AUTHORITY – ACCESS APPROVAL

Agency & Project Name CAL POLY HUMBOLDT Siemens Hall Roof Replacement

Address: 239 Plaza Mall, Arcata, CA 95521 BLDG # 001

GovMotus Control Number: Application #25-N-0678-C-DR

Pursuant to CGR Title 19 §3.00 and §3.05, the California State Fire Marshal is requesting certification from the local fire authority that the above sections are met to their satisfaction.

This form shall be scanned to the accompanying fire access plan reflecting all items under consideration, and wet signed by the local fire authority. Please complete all applicable items based on scope. California State Fire Marshal project approval may be delayed until this form is completed and returned. If you have any questions, please contact the California State Fire Marshal Plan Review Section at (916) 568-2993.

Approved	Yes	No
Fire Department Access	<input checked="" type="checkbox"/>	<input type="checkbox"/>
Fire Department Connection	<input checked="" type="checkbox"/>	<input type="checkbox"/>
Fire Hydrant	<input checked="" type="checkbox"/>	<input type="checkbox"/>
Fire Alarm Annunciator	<input checked="" type="checkbox"/>	<input type="checkbox"/>
Fire Alarm Control Panel	<input checked="" type="checkbox"/>	<input type="checkbox"/>
Knox Box	<input checked="" type="checkbox"/>	<input type="checkbox"/>
Emergency Responder Radio Coverage	<input checked="" type="checkbox"/>	<input type="checkbox"/>
Medical Emergency Service Elevator	<input checked="" type="checkbox"/>	<input type="checkbox"/>
Fire Service Access Elevator	<input checked="" type="checkbox"/>	<input type="checkbox"/>
Bi-Directional Amplification (BDA) Systems	<input checked="" type="checkbox"/>	<input type="checkbox"/>

Local Fire Authority: Arcata Fire Protection District

Address: 2149 Central Ave

City/State/ZIP: Vickierville Ca. 95519

Approval issued by: Ed Laidlaw

Rank/Title: Fire Marshal

Phone Number: (707) 825-2000

Signature: [Signature] Date: 3/25/2025

"The Department of Forestry and Fire Protection serves and safeguards the people and protects the property and resources of California."

GOVMOTUS NUMBER -- XXXXXXXXXXXX

LPAS

Architecture + Design

723 S Street Suite 150 Sacramento CA 95811
916.443.0335 ph
10 Clay Street Suite 250 Oakland CA 94607
415.213.0335 ph
LPAS.com

CAL POLY HUMBOLDT
SIEMENS HALL
ROOF REPLACEMENT

1 HARPST ST
ARCATE, CA 95521

NO. ISSUE DATE

ARCHITECT'S STAMP APPROVAL

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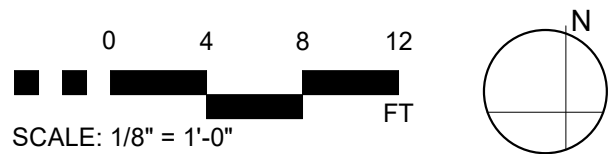
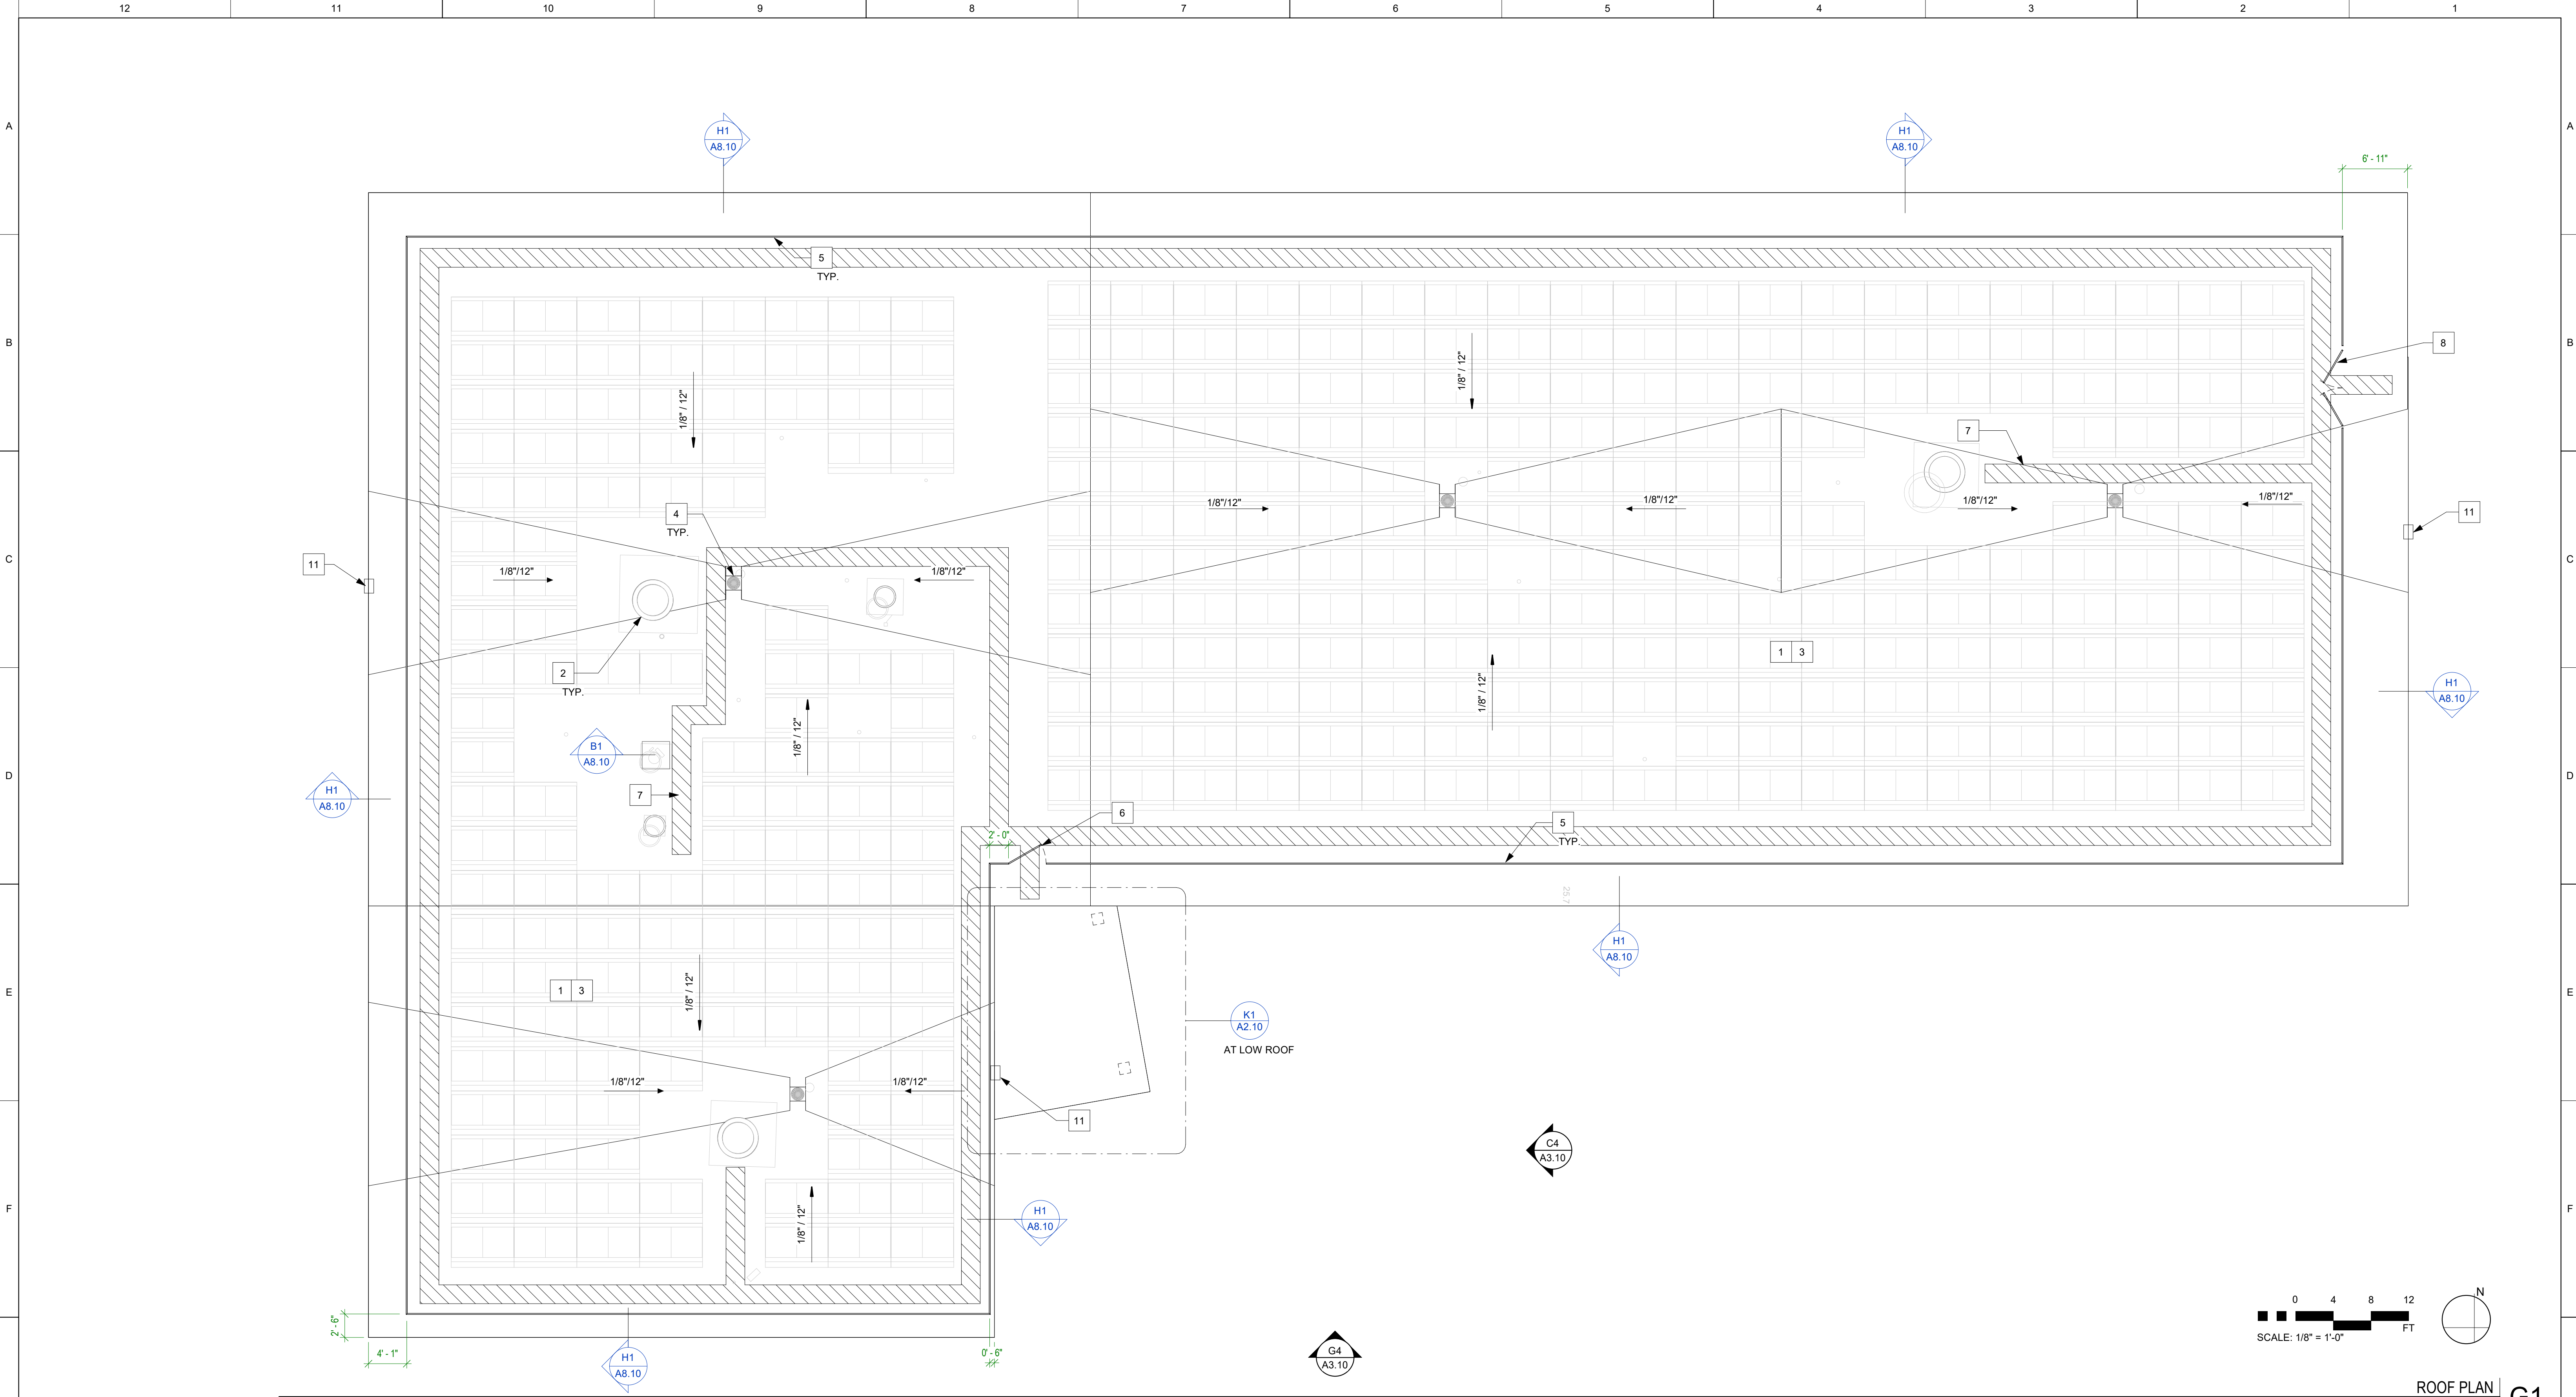
SITE LOGISTICS
AND SAFETY PLAN

PROJECT NO: 1485-0004
DATE: 03/27/2025

SHEET NO:

A1.00

100% CONSTRUCTION DOCUMENTS

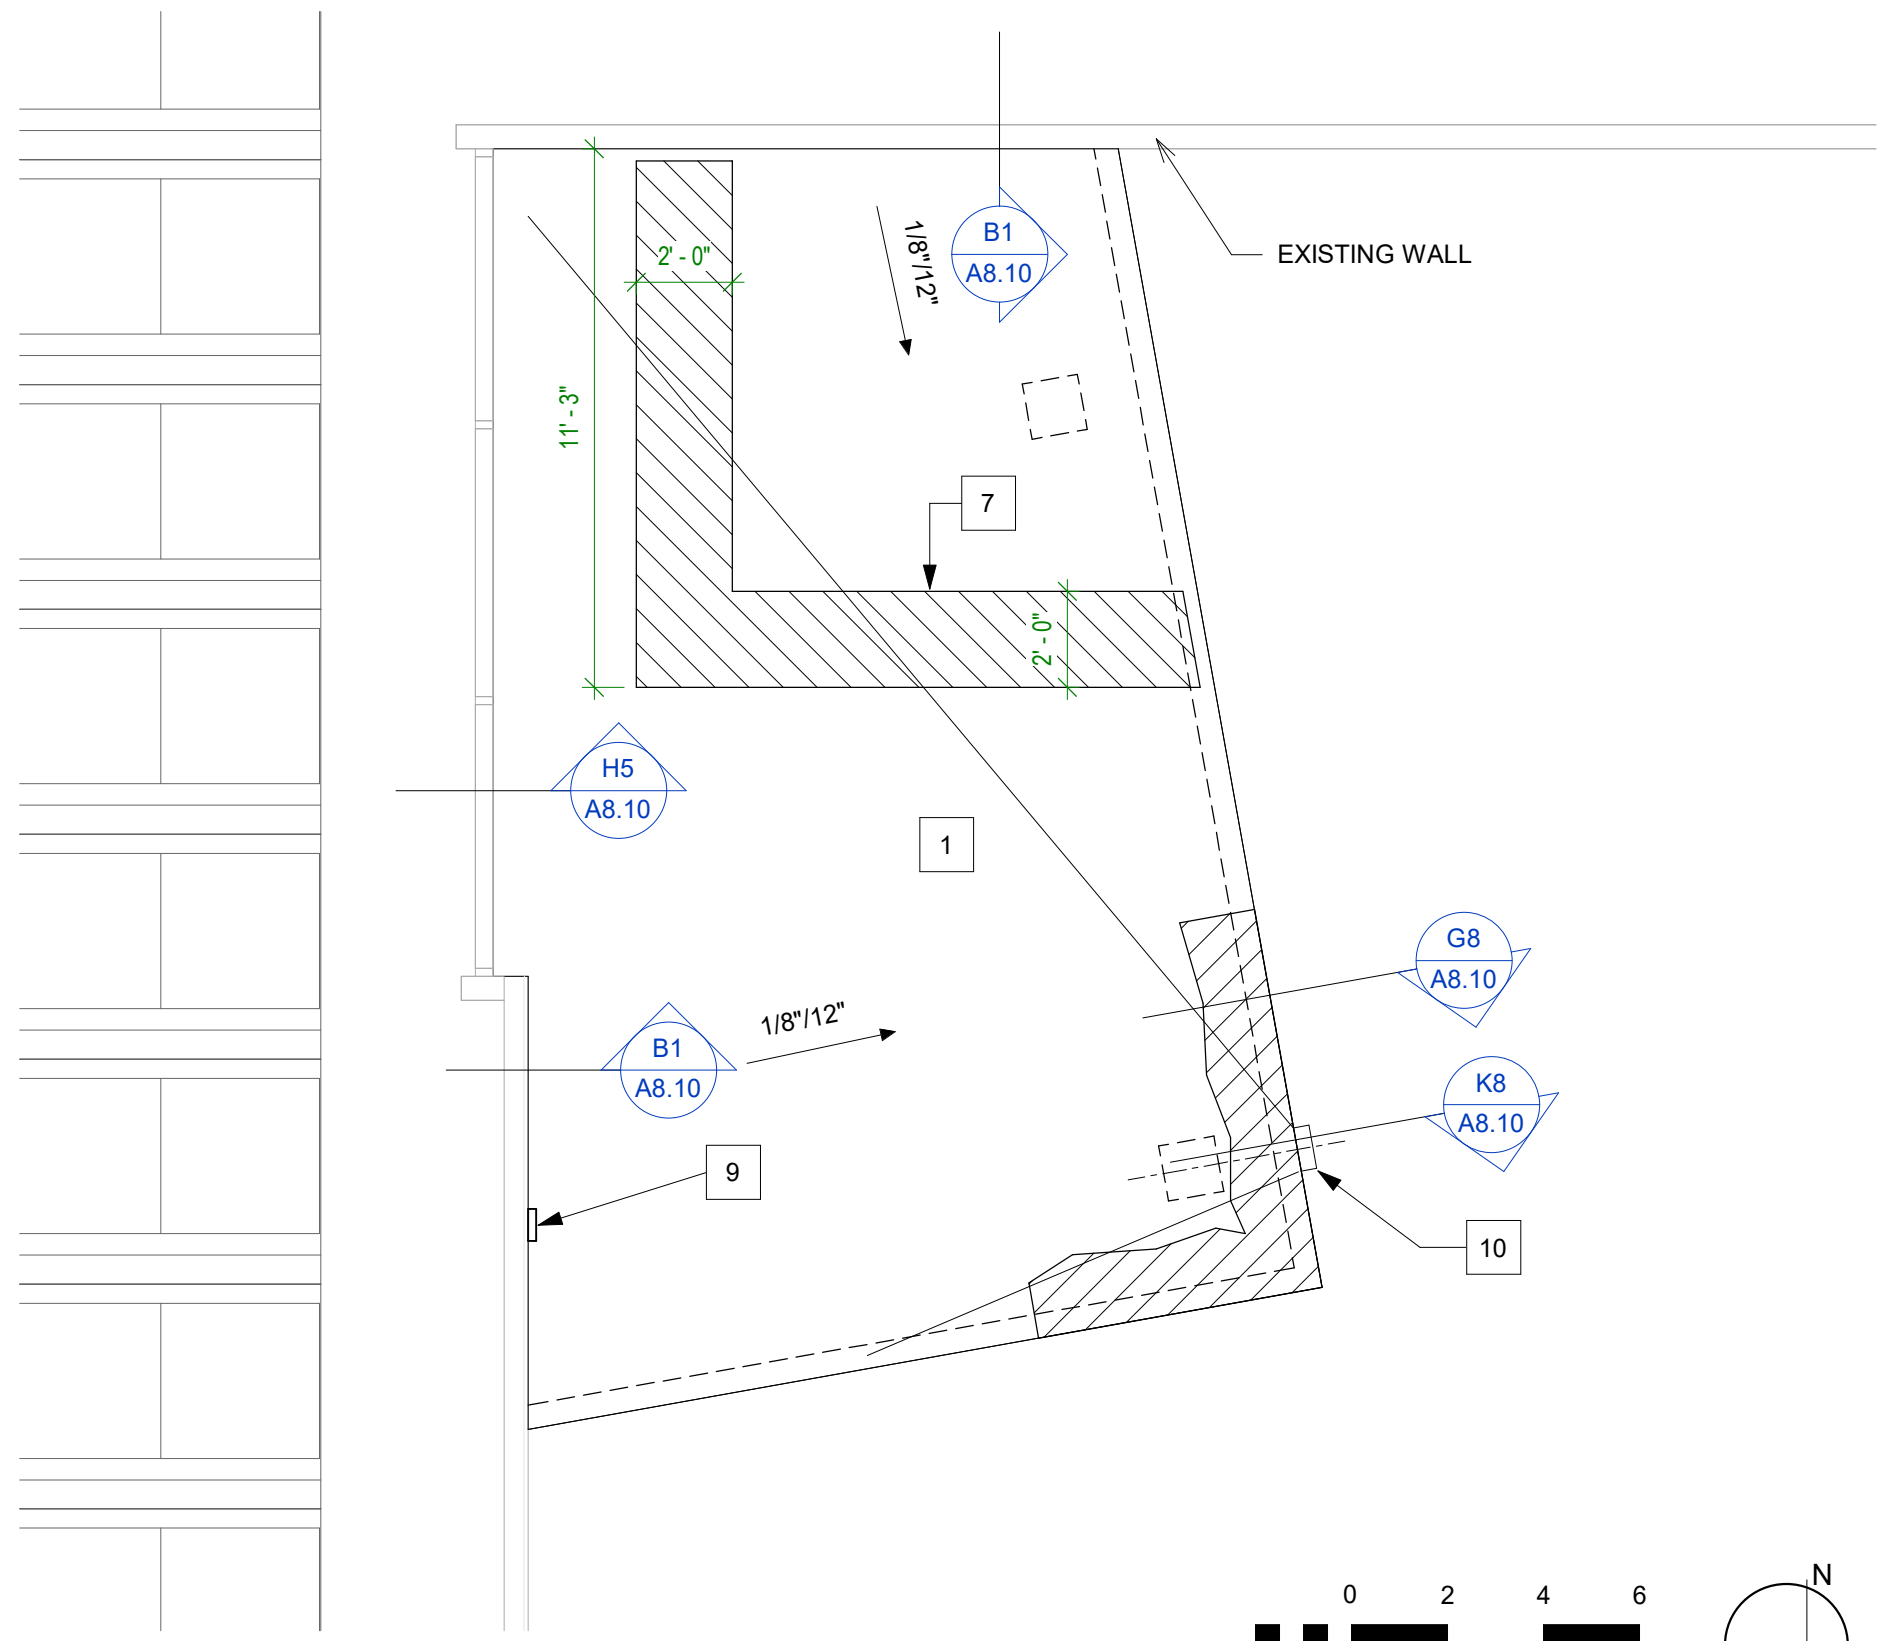


ROOF PLAN
1/8" = 1'-0"

G1

ROOF PLAN LEGEND	
	EXISTING WALL OR OBJECT TO REMAIN
	WALL OR OBJECT
	ROOF DRAIN
	EXHAUST FAN

ROOF PLAN KEYNOTE LEGEND	
1	PVC ROOFING MEMBRANE, OVER ELASTIZELL CONCRETE FILL WITH, R-20 AVERAGE RIGID INSULATION, OVER VAPOR BARRIER, TYP OF ENTIRE BUILDING.
2	REINSTALLATION SALVAGED ROOF MOUNTED EXHAUST FAN ON NEW CURB. REINSTALLATION IN SAME LOCATION, TYP OF ALL UNITS. SEE D5 / A8.10
3	VENT FLASHING TYP. OF ALL VENTS. SEE DETAIL F5 / A8.10
4	ROOF DRAIN, SEE DETAIL K5 / A8.10 TYP OF ALL DRAINS
5	GUARD RAIL SYSTEM, SEE DETAIL F1 / A8.11 TYP.
6	GATE, SEE DETAIL K1 / A8.11
7	WALKING PAD, SEE DETAIL K1 / A8.10
8	DOUBLE GATE, SEE DETAIL K6 / A8.11
9	INSTALL COMPRESSION FITTING CAP.
10	INSTALL SCUPPER AND DOWN SPOUT, TO ALIGN WITH CENTERLINE OF COLUMN BELOW, DAYLIGHT TO PLANTER, SEE DETAIL K8 / A8.10
11	OVER FLOW IN EAVE FLASHING PER DETAIL D8 / A8.10



ENLARGED CANOPY ROOF PLAN - IMPROVEMENT
1/4" = 1'-0"

K1

GOVMOTUS NUMBER -- XXXXXXXXXX

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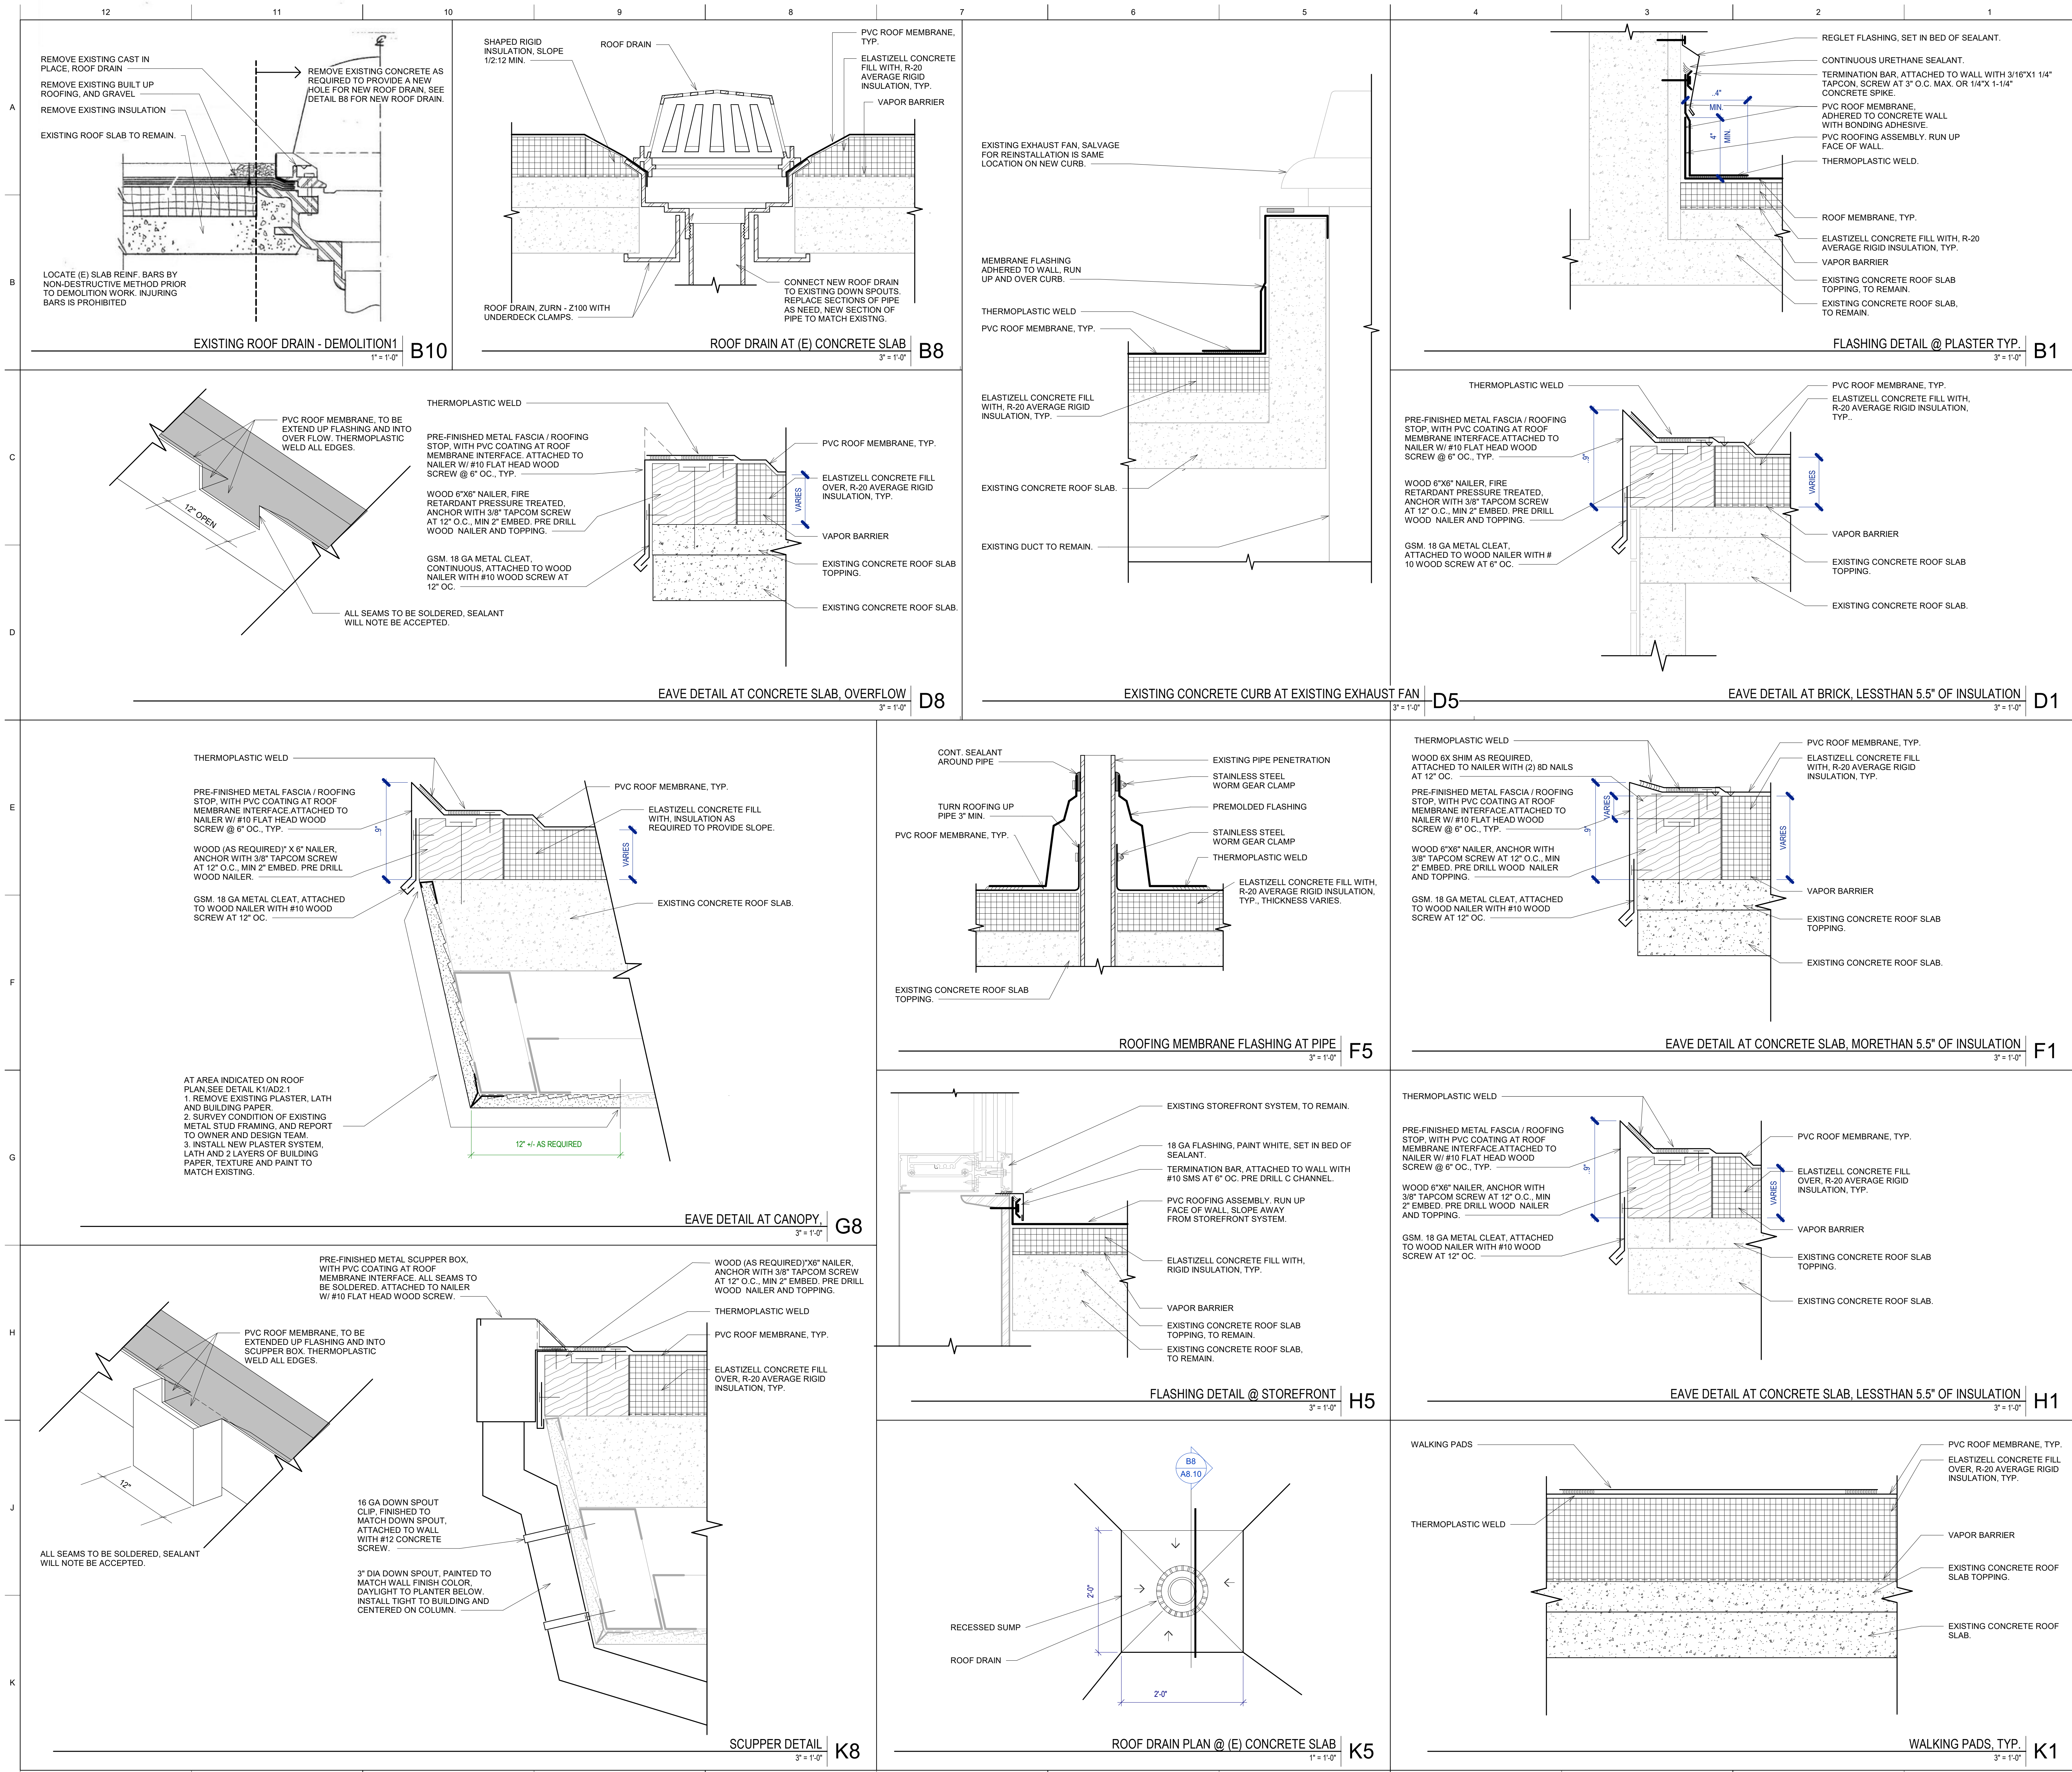
IMPROVEMENT
ROOF PLAN

PROJECT NO: 1485-0004

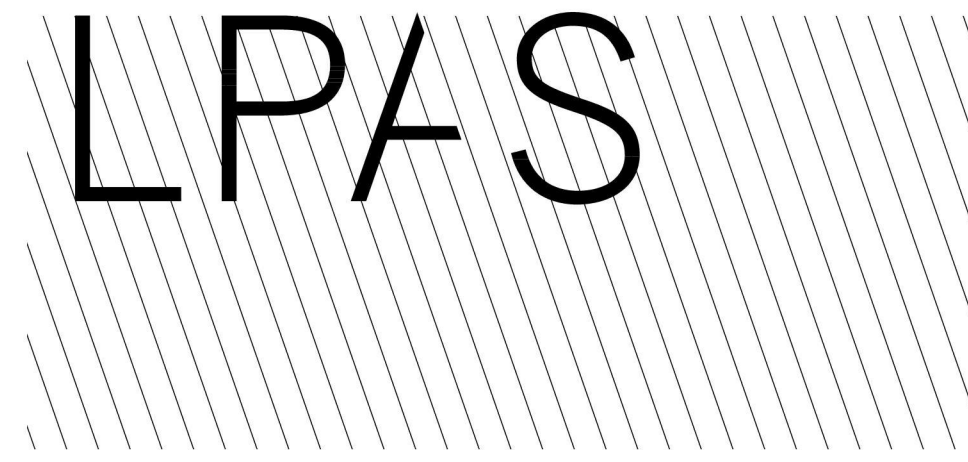
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ROOF DETAILS

PROJECT NO: 1485-0004
DATE: 03/27/2025

SHEET NO:

A8.10

