


CAL POLY HUMBOLDT XPL344 PARKING LOT G11 IMPROVEMENTS


ARCATA, CALIFORNIA

DSA APPLICATION #01-122897 (ACCESS ONLY SET)

CAL POLY HUMBOLDT PERMIT # 2025/26-010 GOVMOTUS PROJECT # EXEMPT

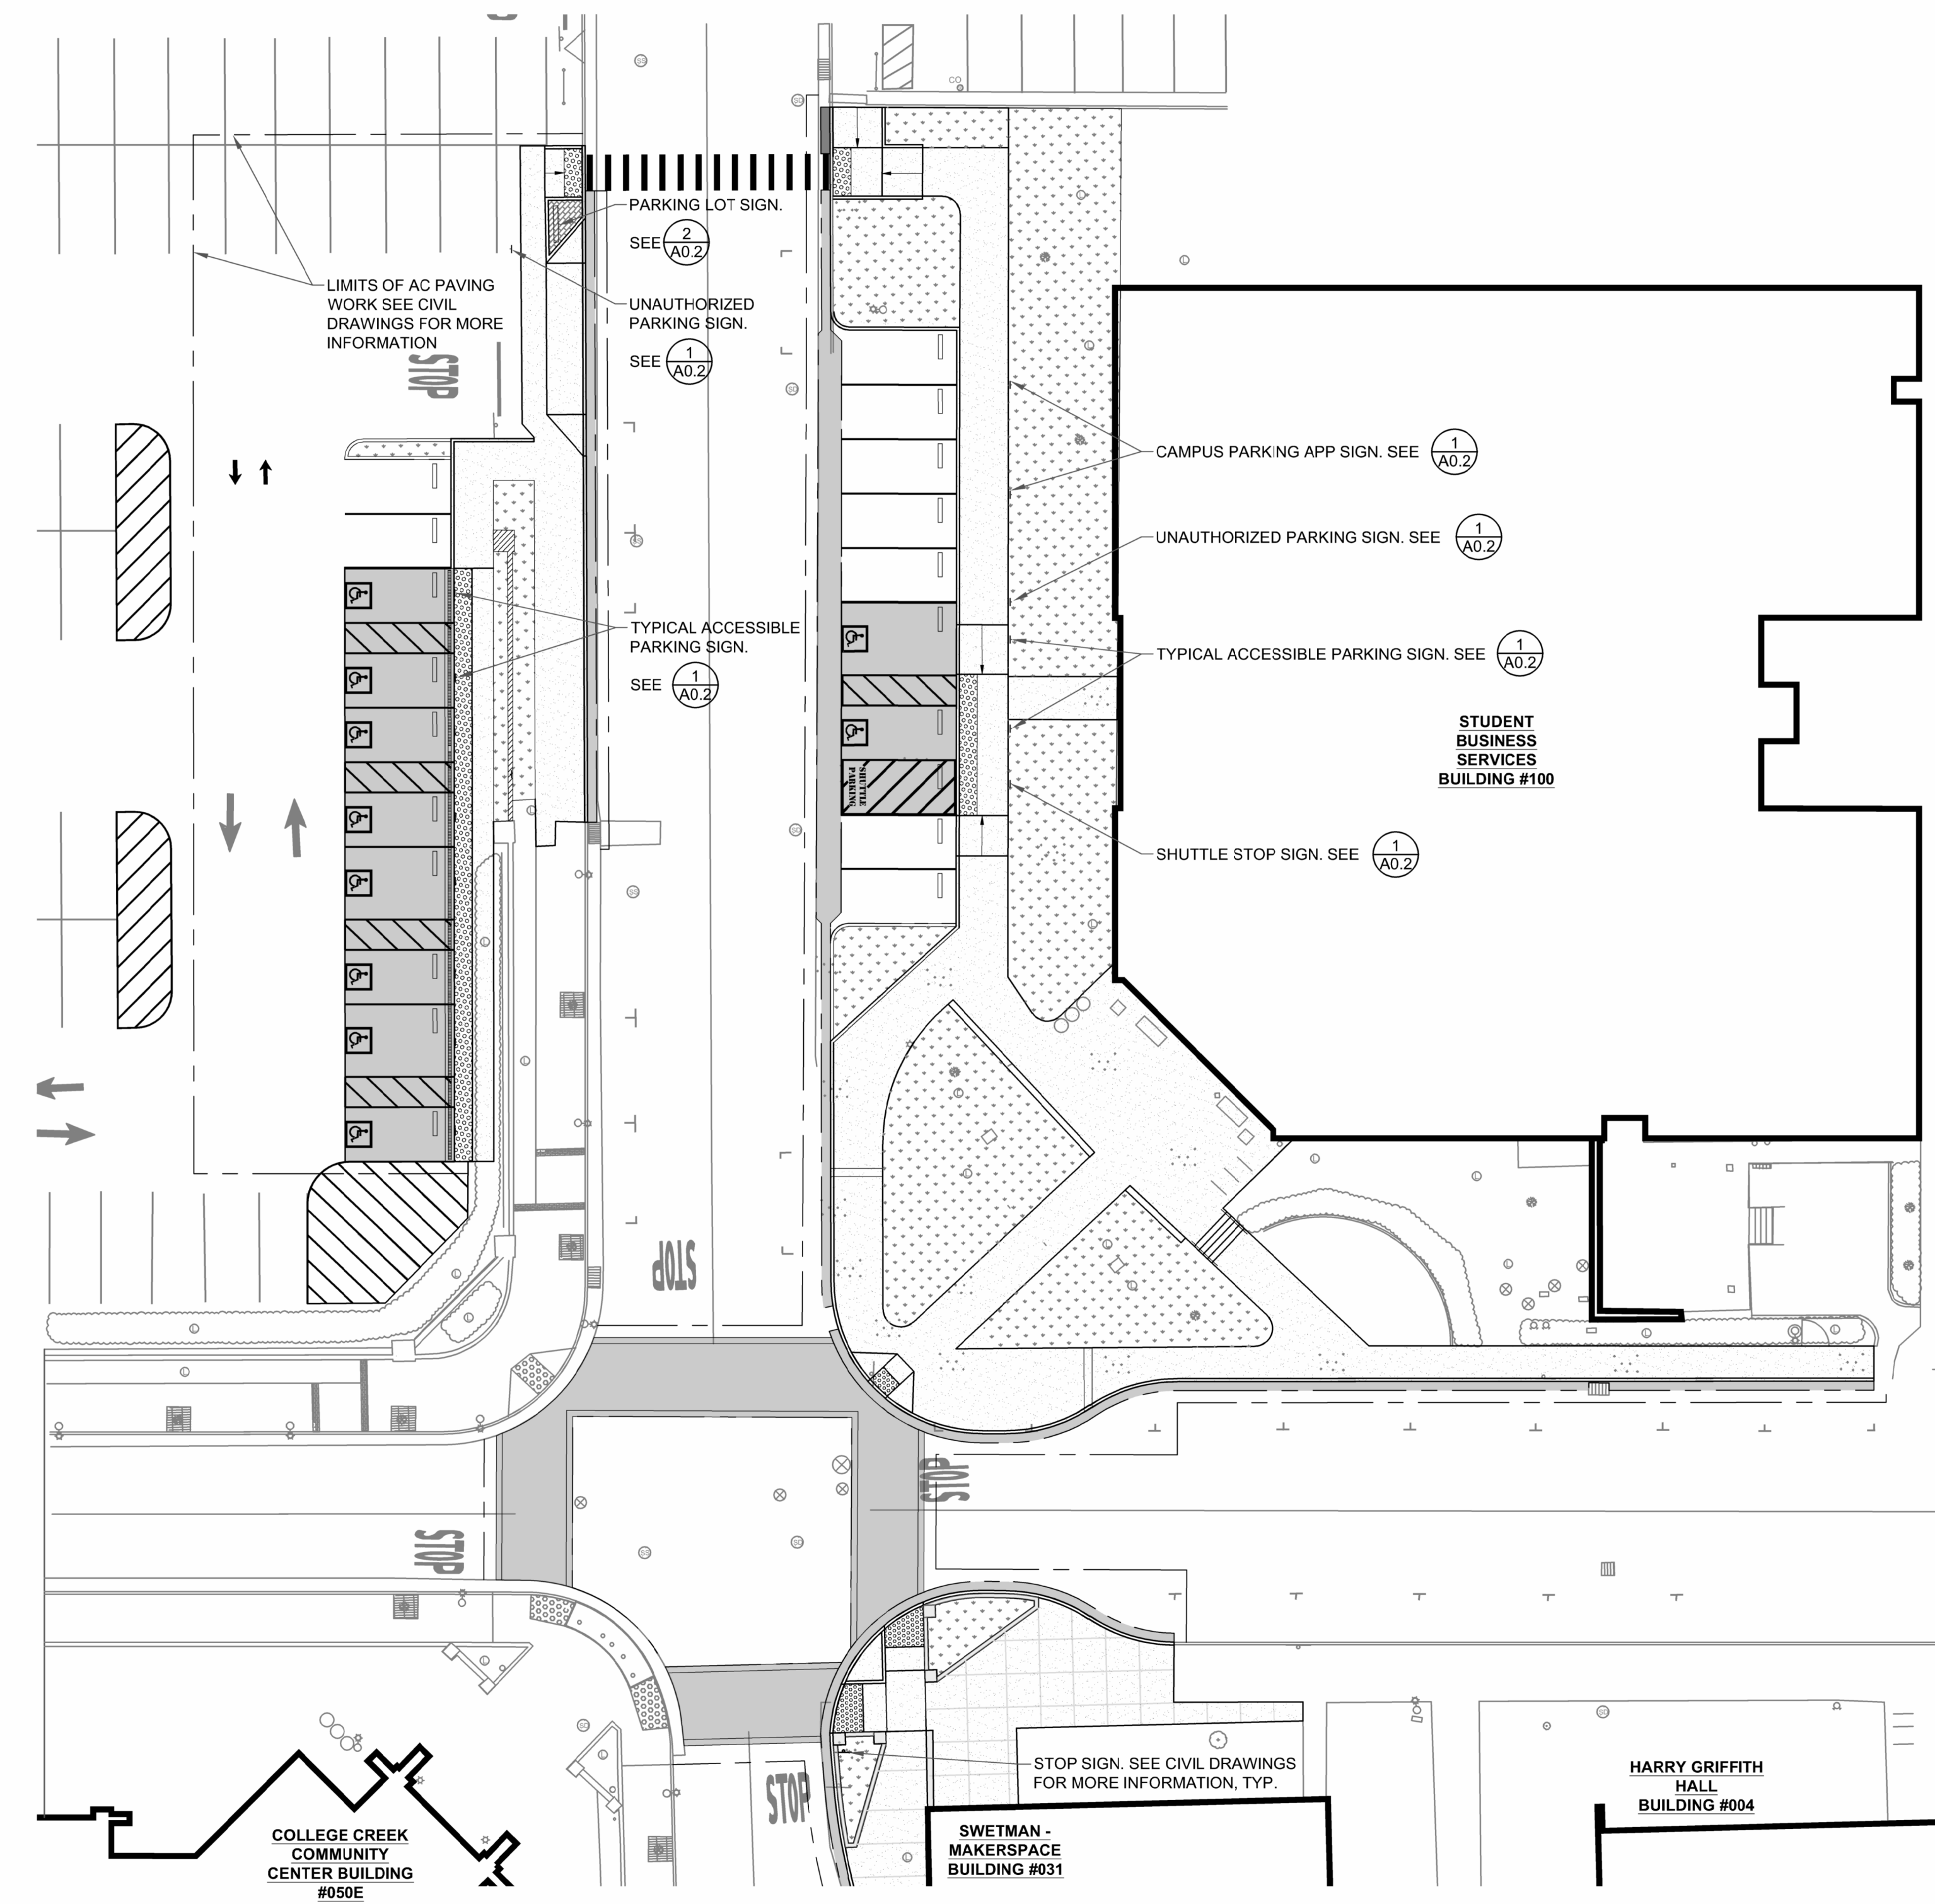

1 **PARKING LOT SITE PLAN**
SCALE: 1" = 20'

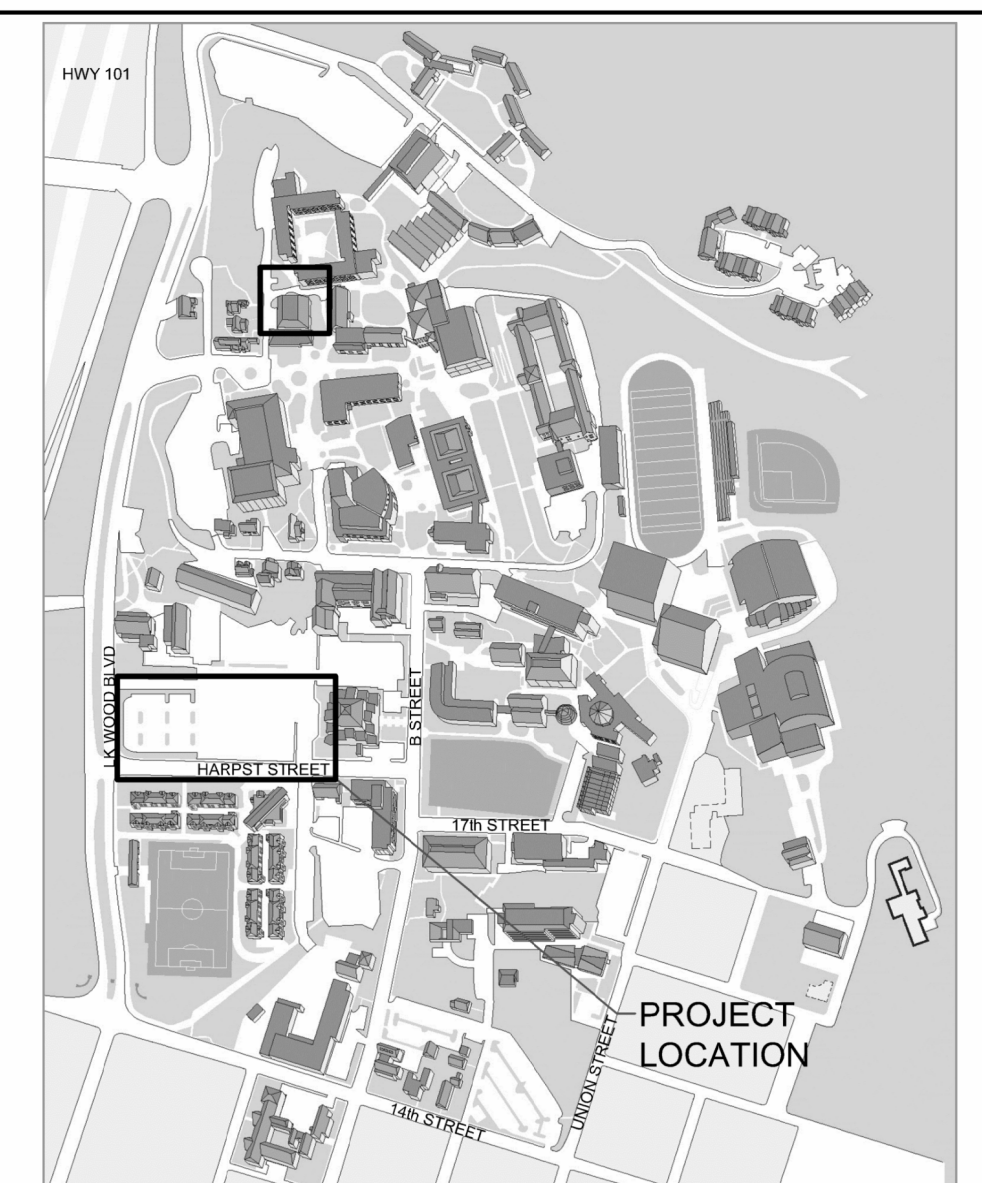

VICINITY MAP

APPLICABLE CODES & STANDARDS FOR PROJECT:

- TITLE 8, CCR, INDUSTRIAL RELATIONS
- TITLE 17, CCR, PUBLIC HEALTH
- TITLE 19, CCR, PUBLIC SAFETY, STATE FIRE MARSHAL REGULATIONS
- 2025 CALIFORNIA ADMINISTRATIVE CODE Title 24, Pt 1
- 2025 CALIFORNIA BUILDING CODE (CBC) Title 24, Pt 2
- 2025 CALIFORNIA ELECTRICAL CODE (CEC) Title 24, Pt 3
- 2025 CALIFORNIA MECHANICAL CODE (CMC) Title 24, Pt 4
- 2025 CALIFORNIA PLUMBING CODE (CPC) Title 24, Pt 5
- 2025 CALIFORNIA ENERGY CODE CCR Title 24, Pt 6
- 2025 CALIFORNIA FIRE CODE (CFC) CCR Title 24, Pt 9
- 2025 CALIFORNIA GREEN BUILDING STANDARDS Title 24, Pt 11
- 2025 CALIFORNIA REFERENCED STANDARDS Title 24, Pt 12

SCOPE OF WORK

IMPROVEMENTS TO AN EXISTING PARKING LOT. WORK INCLUDES THE ADDITION OF NEW ACCESSIBLE PARKING STALLS, GRADING, PAVING, CONCRETE WORK, ELECTRICAL, AND SITE LIGHTING.

DEFERRED SUBMITTAL

STORMWATER POLLUTION PREVENTION PLAN

PARKING ANALYSIS

(SEE CIVIL DRAWING G2.0 FOR MORE INFORMATION)

- TOTAL NUMBER OF STALLS: 290
- STANDARD STALLS: 254
- TOTAL NUMBER OF ACCESSIBLE STALLS: 10
- STANDARD ACCESSIBLE STALLS: 7
- VAN ACCESSIBLE STALLS: 3

DRAWING INDEX

ARCHITECTURAL DRAWINGS	
A0.0	COVERSHEET & PROJECT DATA (THIS SHEET)
A0.1	OVERALL CAMPUS SITE PLAN
A0.2	SIGNAGE PLAN & DETAILS
CIVIL DRAWINGS	
G1.0	COVER
G2.0	PROJECT OVERVIEW AND SITE ACCESS PLAN
G3.0	SITE FIRE ACCESS
C0.0	STANDARD ABBREVIATIONS AND LEGENDS
C1.0	EROSION AND SEDIMENT CONTROL PLAN
C1.1	EROSION AND SEDIMENT CONTROL DETAILS
C1.2	EROSION AND SEDIMENT CONTROL DETAILS
C2.0	DEMOLITION PLAN
C3.0	SITE PLAN
C3.1	ENLARGED SITE PLAN
C3.2	ENLARGED SITE PLAN
C3.3	ENLARGED SITE PLAN
C4.0	GRADING INDEX
C5.0	STORM DRAIN PLAN
C5.1	STORM DRAIN PROFILES
C6.0	UTILITY PLAN
C7.0	RETAINING WALL PLAN
C8.0	DETAILS
C8.1	DETAILS
C8.2	DETAILS
C8.3	DETAILS
C8.4	DETAILS
C8.5	DETAILS
C8.6	DETAILS
LANDSCAPE DRAWINGS	
L1.0	PLANTING PLAN
L2.0	PLANTING DETAILS
L3.0	IRRIGATION PLAN
L3.1	IRRIGATION NOTES AND LEGEND
L3.2	IRRIGATION DETAILS
L3.3	IRRIGATION DETAILS
ELECTRICAL DRAWINGS	
E1.0	ELECTRICAL LEGEND AND SCHEDULES
E1.1	ELECTRICAL DEMOLITION SITE PLAN
E2.0	ELECTRICAL SITE PLAN
E2.1	ELECTRICAL PHOTOMETRIC PLAN
E3.0	ELECTRICAL DETAILS
E4.0	TITLE 24 COMPLIANCE FORMS

PROJECT CONTACTS

- ARCHITECT OF RECORD**
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SHN CONSULTING ENGINEERS
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GROUNDWORKS
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- ELECTRICAL ENGINEER**
FRONTIER CONSULTING ENGINEERS
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- PROJECT MANAGER (OWNER'S REP.)**
CAL POLY HUMBOLDT
PLANNING DESIGN & CONSTRUCTION
SCOTT HARRIS
(707) 826-5904
Scott.Harris@humboldt.edu



PLANNING, DESIGN
& CONSTRUCTION

1 HARPST STREET
ARCATA, CA 95521
707 826-3646



CAL POLY HUMBOLDT
XPL344 PARKING LOT G11
IMPROVEMENTS
HARPST AND ROSSOW STREET,
ARCATA, CA

STATUS

CONSTRUCTION DOCUMENTS

PROJECT #: PLY114
DRAWN BY: HFM

ISSUE DATE: FEB. 25, 2026
BACKCHECK: _____

SHEET TITLE
**COVERSHEET
& PROJECT
DATA**

SHEET
A0.0

LEGEND


- BUILDINGS WITH PREVIOUS DSA APPLICATION #
- BUILDINGS WITH NO DSA APPLICATION #
- AREA OF WORK



G11 PARKING LOT.
AREA OF WORK

UNIVERSITY
PROPERTY LINE

1 OVERALL CAMPUS SITE PLAN
SCALE: NTS

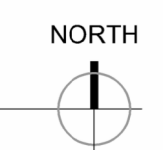

**PLANNING, DESIGN
& CONSTRUCTION**

1 HARPST STREET
ARCATA, CA 95521
707 826-3646



CAL POLY HUMBOLDT
XPL344 PARKING LOT G11
IMPROVEMENTS
HARPST AND ROSSOW STREET,
ARCATA, CA

STATUS

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PROJECT #: PLY114
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ISSUE DATE: FEB. 25, 2026

BACKCHECK: _____

SHEET TITLE


**OVERALL
CAMPUS
SITE PLAN**

SHEET


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GENERAL SIGNAGE NOTES


1. SEE A0.0 & CIVIL DRAWINGS FOR SIGNAGE LOCATIONS
2. CONTRACTOR TO PROVIDE SHOP DRAWINGS FOR UNIVERSITY REVIEW AND APPROVAL PRIOR TO PROCURING SIGNS.
3. ALL SIGNS TO BE REFLECTORIZED SIGNS CONSTRUCTED OF PORCELAIN STEEL WITH BEADED TEXT, OR EQUAL.
4. SECURE TYPICAL PARKING SIGNS TO POST WITH SECURE WITH 3/8" ZINC COATED STEEL DRIVE PIN RIVET OR ALL BRACKETS AND HARDWARE USED SHALL BE GALVANIZED OR APPROVED EQUAL.

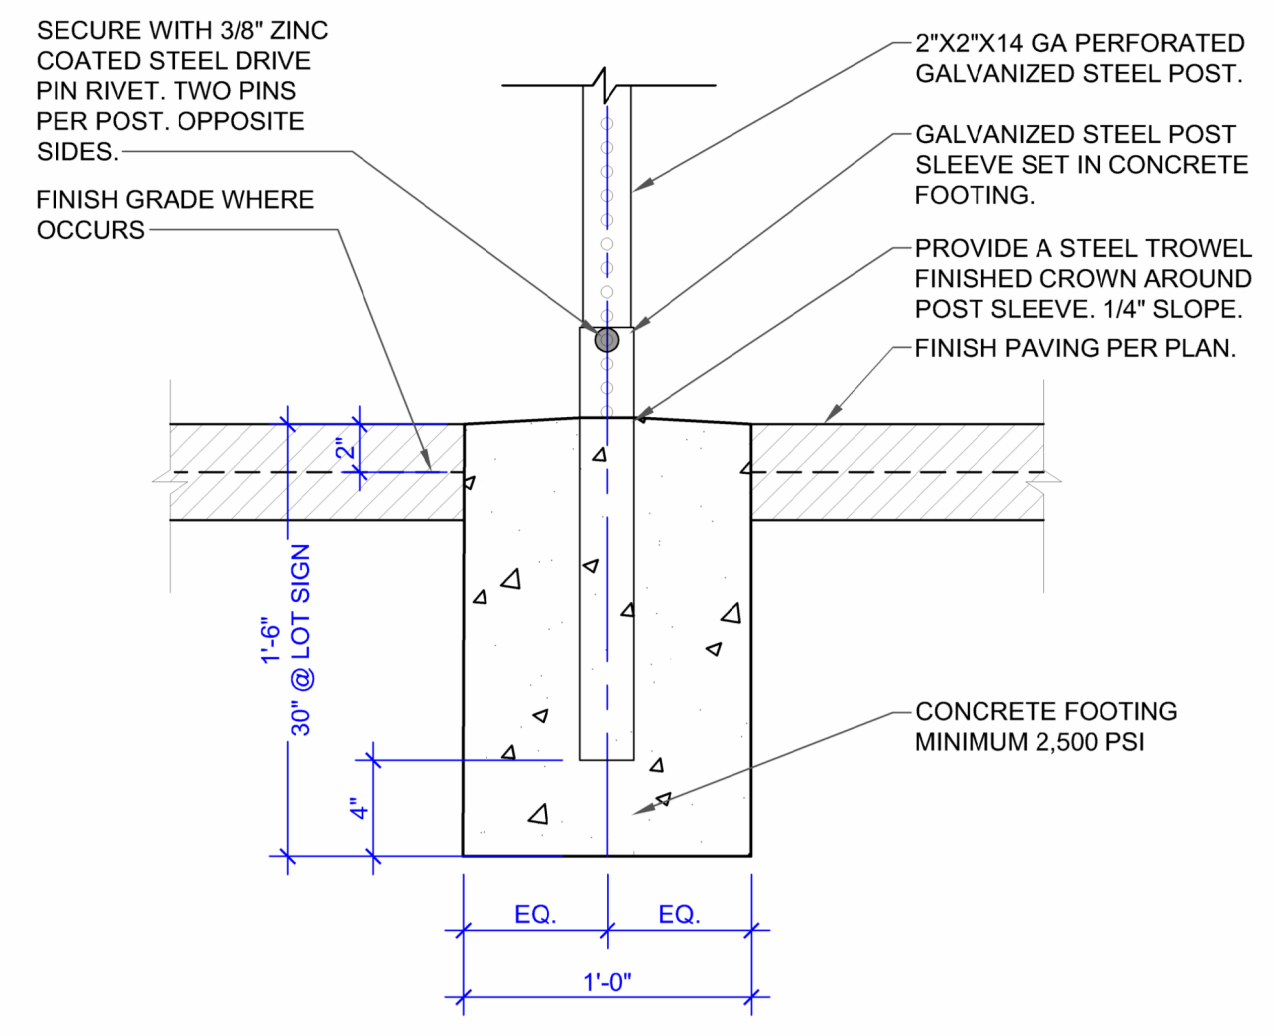


4 SIGN POST FOOTING DETAIL
SCALE: 1-1/2" = 1' - 00"

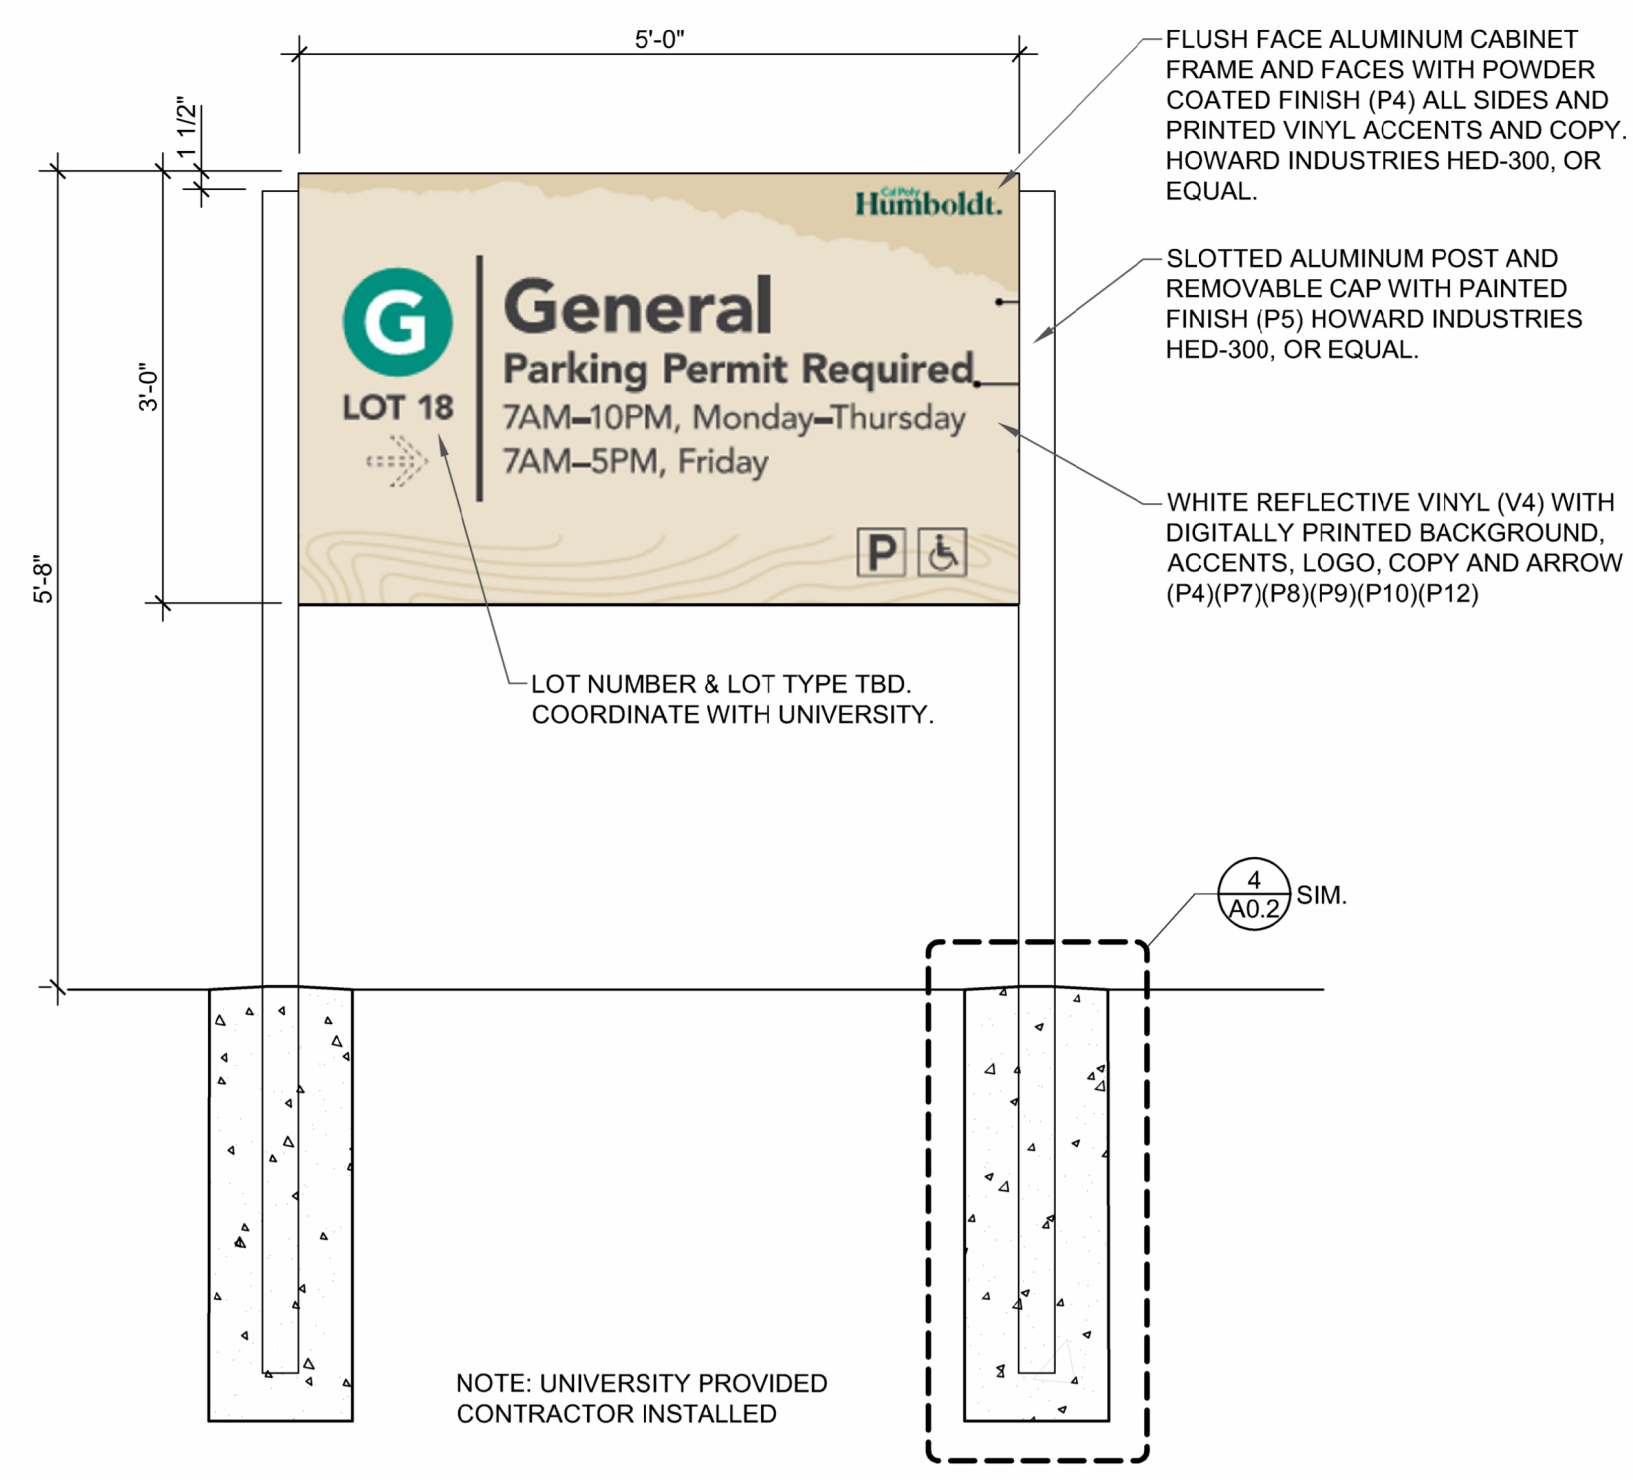

2 TYPICAL PARKING LOT SIGN
SCALE: 1-1/2" = 1' - 0"

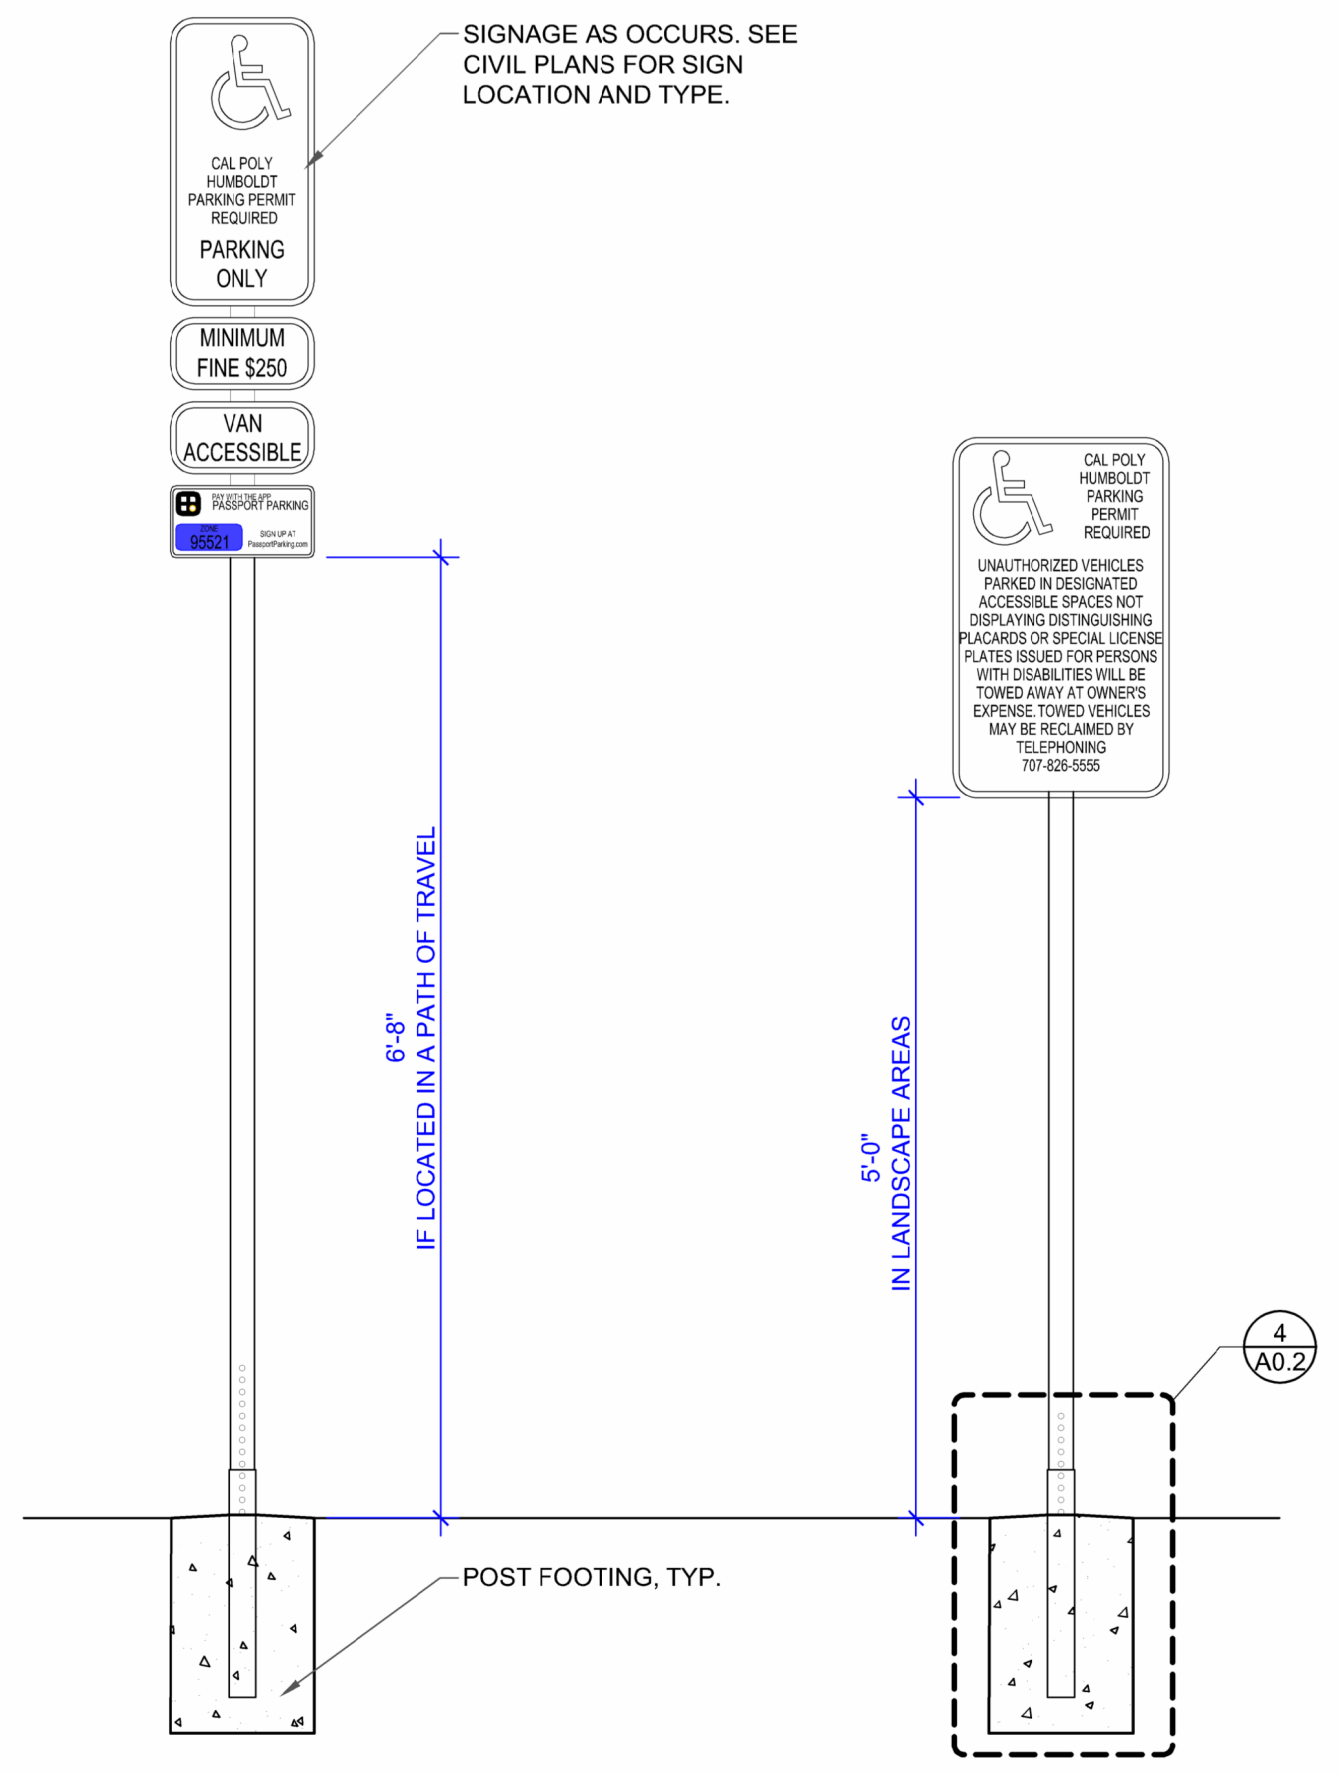

3 TYPICAL PARKING SIGN MOUNTING DETAIL
SCALE: 3/4" = 1' - 0"

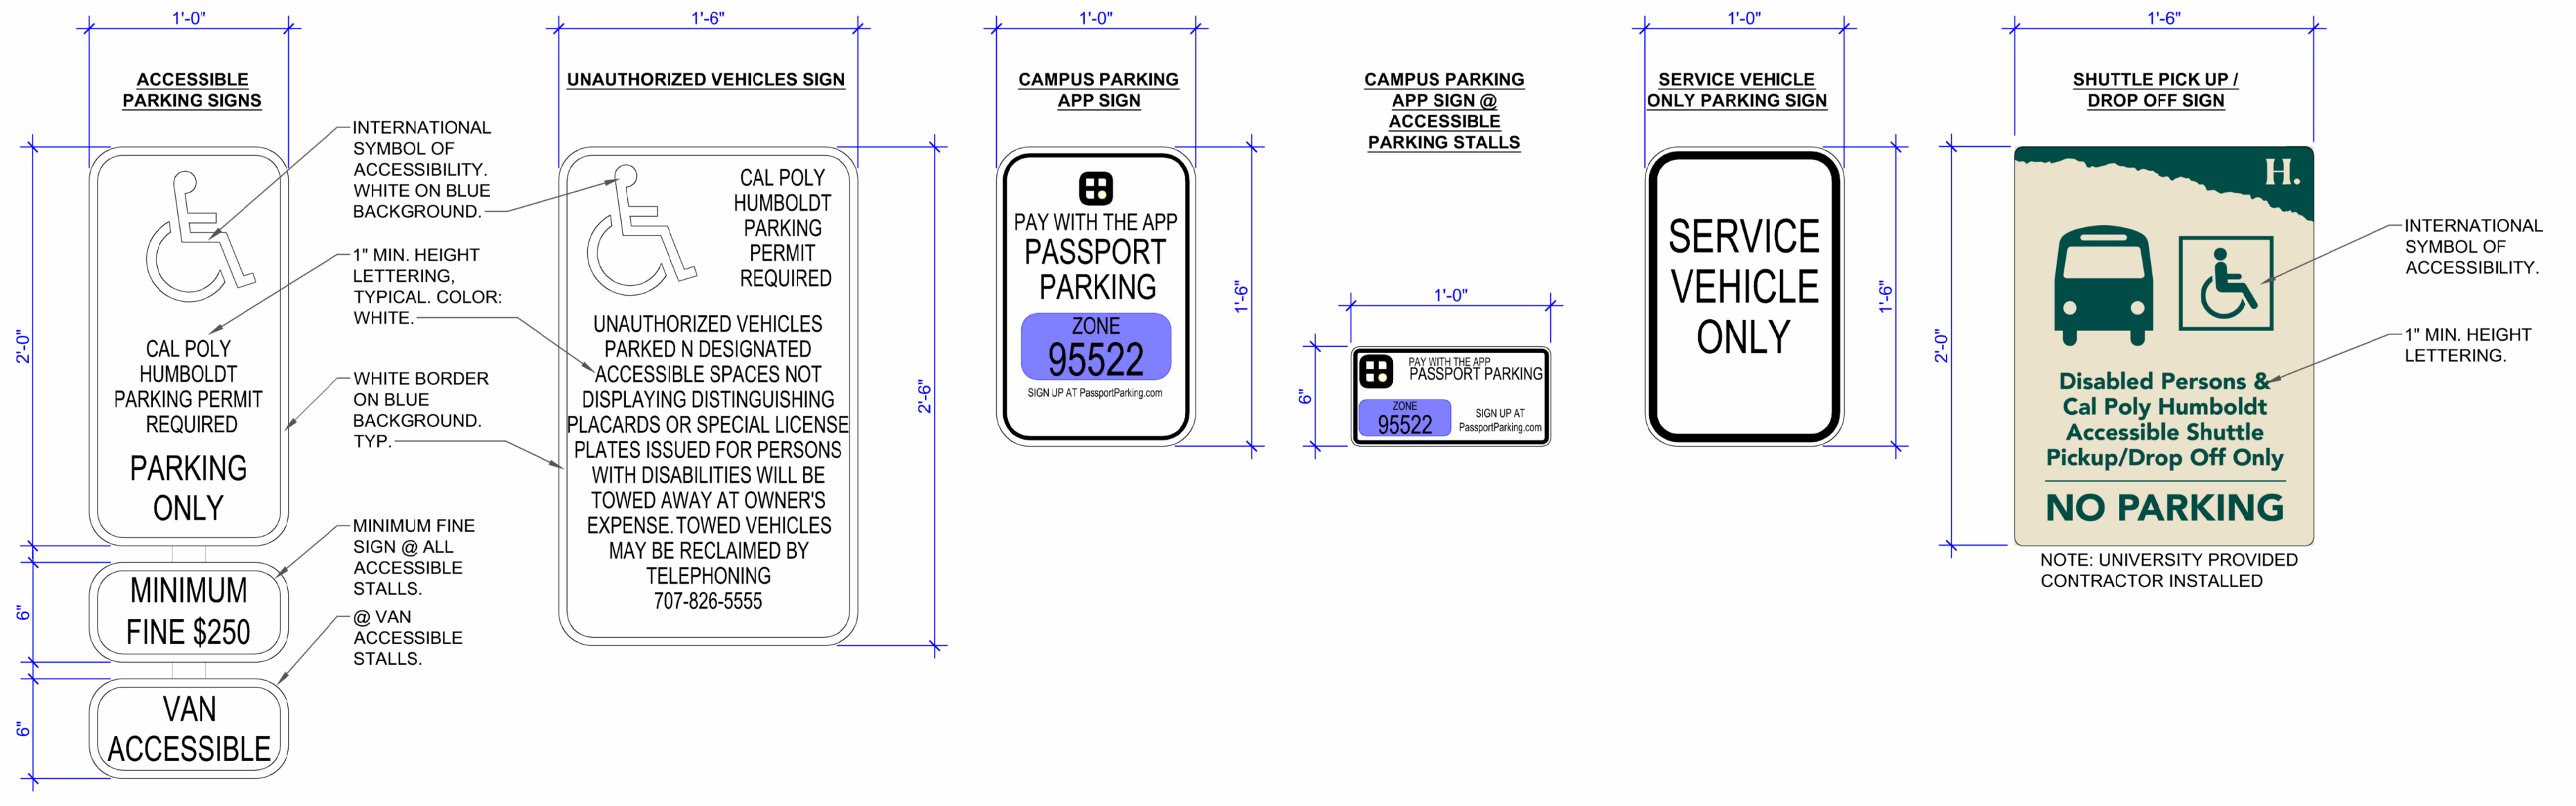

1 TYPICAL PARKING SIGNS
SCALE: 1-1/2" = 1' - 0"

Cal Poly Humboldt.
PLANNING, DESIGN & CONSTRUCTION
1 HARPST STREET
ARCATA, CA 95521
707 826-3646



CAL POLY HUMBOLDT
XPL344 PARKING LOT G11
IMPROVEMENTS
HARPST AND ROSSOW STREET,
ARCATA, CA

STATUS
CONSTRUCTION DOCUMENTS

PROJECT #: PLY114
DRAWN BY: HFM

ISSUE DATE: FEB. 25, 2026
BACKCHECK: _____

SHEET TITLE
SIGNAGE PLAN & DETAILS

SHEET
A0.2

GENERAL NOTES:

- ALL SITE WORK SHALL CONFORM TO 2025 CALIFORNIA BUILDING CODE.
- THESE DRAWINGS ARE GENERALLY DIAGRAMMATIC. THEY DO NOT SHOW EVERY OFFSET, BEND OR ELBOW REQUIRED FOR INSTALLATION IN THE SPACE PROVIDED. THEY DO NOT SHOW EVERY DIMENSION, COMPONENT PIECE, SECTION, JOINT OR FITTING REQUIRED TO COMPLETE THE PROJECT.
- ALL LOCATIONS FOR WORK SHALL BE CHECKED AND COORDINATED WITH EXISTING CONDITIONS IN THE FIELD BY THE CONTRACTOR BEFORE BEGINNING CONSTRUCTION. EXISTING UNDERGROUND UTILITIES WITHIN THE LIMITS OF EXCAVATION SHALL BE VERIFIED AS TO CONDITION, SIZE AND LOCATION BY UNCOVERING, PROVIDED SUCH IS PERMITTED BY LOCAL PUBLIC AUTHORITIES WITH JURISDICTION, BEFORE BEGINNING CONSTRUCTION. CONTRACTOR SHALL NOTIFY ENGINEER OF ANY DISCREPANCIES.
- CONTRACTOR SHALL PERFORM TRENCH WORK IN CONFORMANCE WITH THE CALIFORNIA DIVISION OF INDUSTRIAL SAFETY REQUIREMENTS AND SHALL CONFORM TO ALL APPLICABLE OCCUPATIONAL SAFETY AND HEALTH ADMINISTRATION STANDARDS (OSHA), RULES, REGULATIONS AND ORDERS ESTABLISHED BY THE STATE OF CALIFORNIA AND OTHER APPLICABLE AGENCIES.
- CONTRACTOR AGREES THAT IN ACCORDANCE WITH GENERALLY ACCEPTED CONSTRUCTION PRACTICES, GENERAL CONTRACTOR WILL ASSUME SOLE AND COMPLETE RESPONSIBILITY FOR JOB SITE CONDITIONS DURING THE COURSE OF CONSTRUCTION OF THE PROJECT, INCLUDING SAFETY OF ALL PERSONS AND PROPERTY. ALL WORK AND EQUIPMENT SHALL COMPLY WITH THE CALIFORNIA DIVISION OF INDUSTRIAL SAFETY REQUIREMENTS. THIS REQUIREMENT SHALL BE MADE TO APPLY CONTINUOUSLY, AND NOT BE LIMITED TO NORMAL WORKING HOURS. CONTRACTOR FURTHER AGREES TO HOLD HARMLESS, INDEMNIFY AND DEFEND THE OWNER, THE ENGINEER AND THEIR CONSULTANTS.
- THE CONTRACTOR SHALL INDEPENDENTLY REVIEW GROUND, TOPOGRAPHY AND TREE CONDITIONS THROUGHOUT THE SITE, AND ASSUME THE RISK OF COMPLETING THE WORK SET OUT ON THESE PLANS, REGARDLESS OF ROCK, WATER TABLE OR OTHER CONDITIONS WHICH MAY BE ENCOUNTERED IN THE COURSE OF THE WORK.
- ANY DISCREPANCY DISCOVERED BY THE CONTRACTOR IN THESE PLANS, OR ANY FIELD CONDITIONS DISCOVERED BY THE CONTRACTOR THAT MAY DELAY OR OBSTRUCT THE PROPER COMPLETION OF THE WORK SHOWN HEREIN SHALL BE BROUGHT TO THE ATTENTION OF THE OWNER AND THE ENGINEER IMMEDIATELY UPON DISCOVERY. SAID NOTIFICATION SHALL BE IN WRITING.
- ALL UNDERGROUND IMPROVEMENTS SHALL BE INSTALLED TESTED AND APPROVED PRIOR TO PAVING.
- THE CONTRACTOR SHALL NOT BEGIN EXCAVATING UNTIL ALL EXISTING UTILITIES HAVE BEEN MARKED IN THE FIELD. THE CONTRACTOR SHALL NOTIFY EACH APPLICABLE ENTITY AT LEAST 48 HOURS PRIOR TO COMMENCING WORK. CALL UNDERGROUND SERVICE ALERT (USA) TWO WORKING DAYS BEFORE DIGGING AT 811 FOR LOCATES.
- CONTRACTORS SHALL STOP WORK AND NOTIFY THE OWNER AND THE ENGINEER IF CULTURAL RESOURCES ARE DISCOVERED DURING CONSTRUCTION. WORK IN THAT AREA SHALL NOT RESUME UNTIL APPROVAL IS GIVEN BY THE OWNER AND ENGINEER.
- THE CONTRACTOR SHALL GIVE THE SPECIAL INSPECTOR 48 HOURS ADVANCE NOTICE OF ANY CONSTRUCTION OR REQUIRED TESTING.
- SHOULD THE CONTRACTOR OR ANY OF THEIR AGENTS OR EMPLOYEES ENCOUNTER OR DISCOVER MATERIALS WHICH APPEAR TO BE HAZARDOUS DURING THE PERFORMANCE OF THE WORK, THE CONTRACTOR SHALL INFORM THE ENGINEER IMMEDIATELY AND SUSPEND WORK IN THE AFFECTED AREA UNTIL THE ENGINEER HAS INSPECTED THE LOCATION AND MATERIALS IN QUESTION. SHOULD IT BE NECESSARY TO UNDERTAKE REMEDIATION, THE ENGINEER WILL GIVE WRITTEN NOTICE TO SUSPEND WORK IN THE AFFECTED AREA UNTIL THE PROPER COURSE OF ACTION HAS BEEN DETERMINED. OPERATIONS IN THE AFFECTED AREA SHALL BE RESUMED ONLY UPON WRITTEN NOTICE BY THE ENGINEER.
- ALL SITE GRADING WILL BE INSPECTED. COMPACTION TESTING WILL BE CONDUCTED AFTER SUFFICIENT DENSITIES HAVE BEEN ACHIEVED IN THE CONTRACTOR'S OPINION. THE CONTRACTOR SHALL MAKE ALL REQUESTS FOR MATERIALS TESTING AT LEAST 48 HOURS IN ADVANCE. ANY SOILS THAT FAIL TO MEET THE REQUIRED COMPACTION LEVELS SHALL BE REMOVED, AND RECOMPACTED. ALL COSTS ASSOCIATED WITH ACHIEVING COMPACTION STANDARDS SHALL BE INCLUDED IN THE CONTRACTOR'S ORIGINAL BID.
- TOPSOIL SHALL BE REMOVED FROM CUT AND FILL AREAS AND SHALL NOT BE USED FOR ENGINEERED FILL.
- NO CHANGES OR MODIFICATIONS SHALL BE MADE TO THESE PLANS WITHOUT WRITTEN APPROVAL BY THE ENGINEER.
- CONTRACTOR SHALL OBTAIN AN ENCROACHMENT PERMIT FROM THE CITY PRIOR TO PROCEEDING WITH ANY CONSTRUCTION ACTIVITIES OR TRAFFIC CONTROL WITHIN THE CITY RIGHT OF WAY. THE CITY SHALL BE PRESENT DURING ALL WORK ON CITY UTILITIES.
- ANY DAMAGE TO EXISTING CITY FACILITIES DURING CONSTRUCTION SHALL BE REPAIRED ACCORDING TO CITY REQUIREMENTS BY THE CONTRACTOR.

UTILITIES LEGEND

EXISTING

- DROP INLET
- PARKING METER
- HYDRANT
- GAS METER
- GUY ANCHOR
- HOSE BIBB
- JOINT POLE
- LANDSCAPING
- LIGHT POLE
- POLE MOUNTED LUMINAIRE
- CLEANOUTS
- STORM DRAIN MANHOLE
- UTILITY POLE
- VAULT
- WATER METER
- WATER VALVE
- DOWN SPOUT
- WATER LINE
- OVERHEAD ELECTRIC
- ELECTRICAL LINE
- GAS LINE
- COMMUNICATION LINE
- STORM DRAIN LINE
- SANITARY SEWER LINE
- FIBER OPTIC LINE

PROPOSED

- ELECTRICAL LINE
- STORM DRAIN LINE
- PIPE SIZE AND FLOW DIRECTION
- DRAINAGE INLET

ABBREVIATIONS AND LEGEND NOTES

- CONTACT THE ENGINEER FOR SYMBOLS OR ABBREVIATIONS NOT LISTED.
- SITE AND UTILITY SYMBOLS SHOWN ON THIS SHEET ARE NOT INTENDED TO REPRESENT THE PHYSICAL SCALE OR SHAPE OF ANY ITEMS. WHERE LARGE-SCALE PLANS ARE PRESENTED, THE SYMBOLS SHOWN HEREON MAY BE REPLACED BY DETAILS MORE SUITED TO THE DRAWING SCALE.

ABBREVIATIONS

A	
@	AT
AC	ASPHALTIC CONCRETE
ADA	AMERICANS WITH DISABILITIES ACT
AGGR	AGGREGATE
ARCH	ARCHITECT
B	
BMP	BEST MANAGEMENT PRACTICE
BOF	BOTTOM OF FOOTING
C	
CBC	CALIFORNIA BUILDING CODE
CL	CENTER LINE
CLR	CLEAR
CONC	CONCRETE
D	
DIA	DIAMETER
E	
(E)	EXISTING
EG	EXISTING GROUND
ELEC	ELECTRIC
ESCP	EROSION AND SEDIMENT CONTROL PLAN
EW	EACH WAY
F	
FF	FINISHED FLOOR
FG	FINISHED GRADE
FL	FLOW LINE
H	
H	HORIZONTAL
HORIZ	HORIZONTAL
HDPE	HIGH-DENSITY POLYETHYLENE
I	
ID	INSIDE DIAMETER
INV	INVERT
ISA	INTERNATIONAL SYMBOL OF ACCESSIBILITY
K	
KSI	KILOPOUNDS PER SQUARE INCH
M	
MAX	MAXIMUM
MIN	MINIMUM
N	
(N)	NEW
NIC	NOT IN CONTRACT
NTS	NOT TO SCALE
O	
OC	ON CENTER
OD	OUTSIDE DIAMETER
P	
PSI	POUNDS PER SQUARE INCH
PVC	POLYVINYL CHLORIDE PLASTIC
R	
R	RADIUS
RC	RELATIVE COMPACTION
REQD	REQUIRED
RWQCB	REGIONAL WATER QUALITY CONTROL BOARD
S	
S	SLOPE
SD	STORM DRAIN
STA	STATION
STD	STANDARD
T	
TC	TOP OF CURB
TOC	TOP OF CONCRETE
TOG	TOP OF GRATE
TOF	TOP OF FOOTING
TOW	TOP OF WALL
TYP	TYPICAL
V	
V	VERTICAL
VAR	VARIES

SITE CIVIL SUBMITTALS	
AGGREGATE BASE	
AC MIX	
ENGINEERED FILL MATERIAL FOR SITE WORK - IMPORT AND NATIVE	
SITE CONCRETE MIX DESIGN AND JOINTING MATERIALS	
SITE REBAR	
STORM DRAIN PIPING, TRENCH DRAIN, AND STRUCTURES	
TRUNCATED DOMES	
WHEEL STOP	
ADA PARKING SIGNAGE	
STRIPING/TRAFFIC PAINT	
ORNAMENTAL METAL FENCE	

SITE CIVIL SPECIAL INSPECTIONS	
OBSERVATION	
SUBGRADE INSPECTION AND PROOF-ROLL OBSERVATION - GEOTECHNICAL ENGINEER OF RECORD	
PAVEMENT SURFACE DRAINAGE TESTING - INSPECTOR OF RECORD	
COMPACTION TESTING	
ENGINEERED FILL MATERIAL - MATERIALS TESTING LAB	
AGGREGATE BASE MATERIAL - MATERIALS TESTING LAB	
TRENCH BACKFILL - MATERIALS TESTING LAB	
CONCRETE COMPRESSIVE STRENGTH TESTING	
VEHICULAR CONCRETE - MATERIALS TESTING LAB	
SITE RETAINING WALLS - MATERIALS TESTING LAB	



812 W. WABASH AVE.
EUREKA, CA. 95501
WWW.SHN-ENGR.COM
707-441-8855

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BAR IS ONE INCH ON ORIGINAL DRAWING
0 1"
IF NOT ONE INCH ON THIS SHEET, ADJUST SCALES ACCORDINGLY



NO.	DATE	REVISION

CAL POLY HUMBOLDT
CPH G11 PARKING LOT
ARCATA, CALIFORNIA


STANDARD ABBREVIATIONS AND LEGENDS

DATE	02/2026	DSGN	CC
PROJ. NO.	025150	DR	CDN/JWF
		CHK	JSO

SHEET
C0.0



SAVED: 2/25/2026 1:43 PM JFOSTER, PLOTTED: 2/25/2026 1:55 PM JOHN FOSTER
P:\Eureka\2025\025150-CPH-G11-Parking-Lot\Drawings\025150-DEM0.dwg

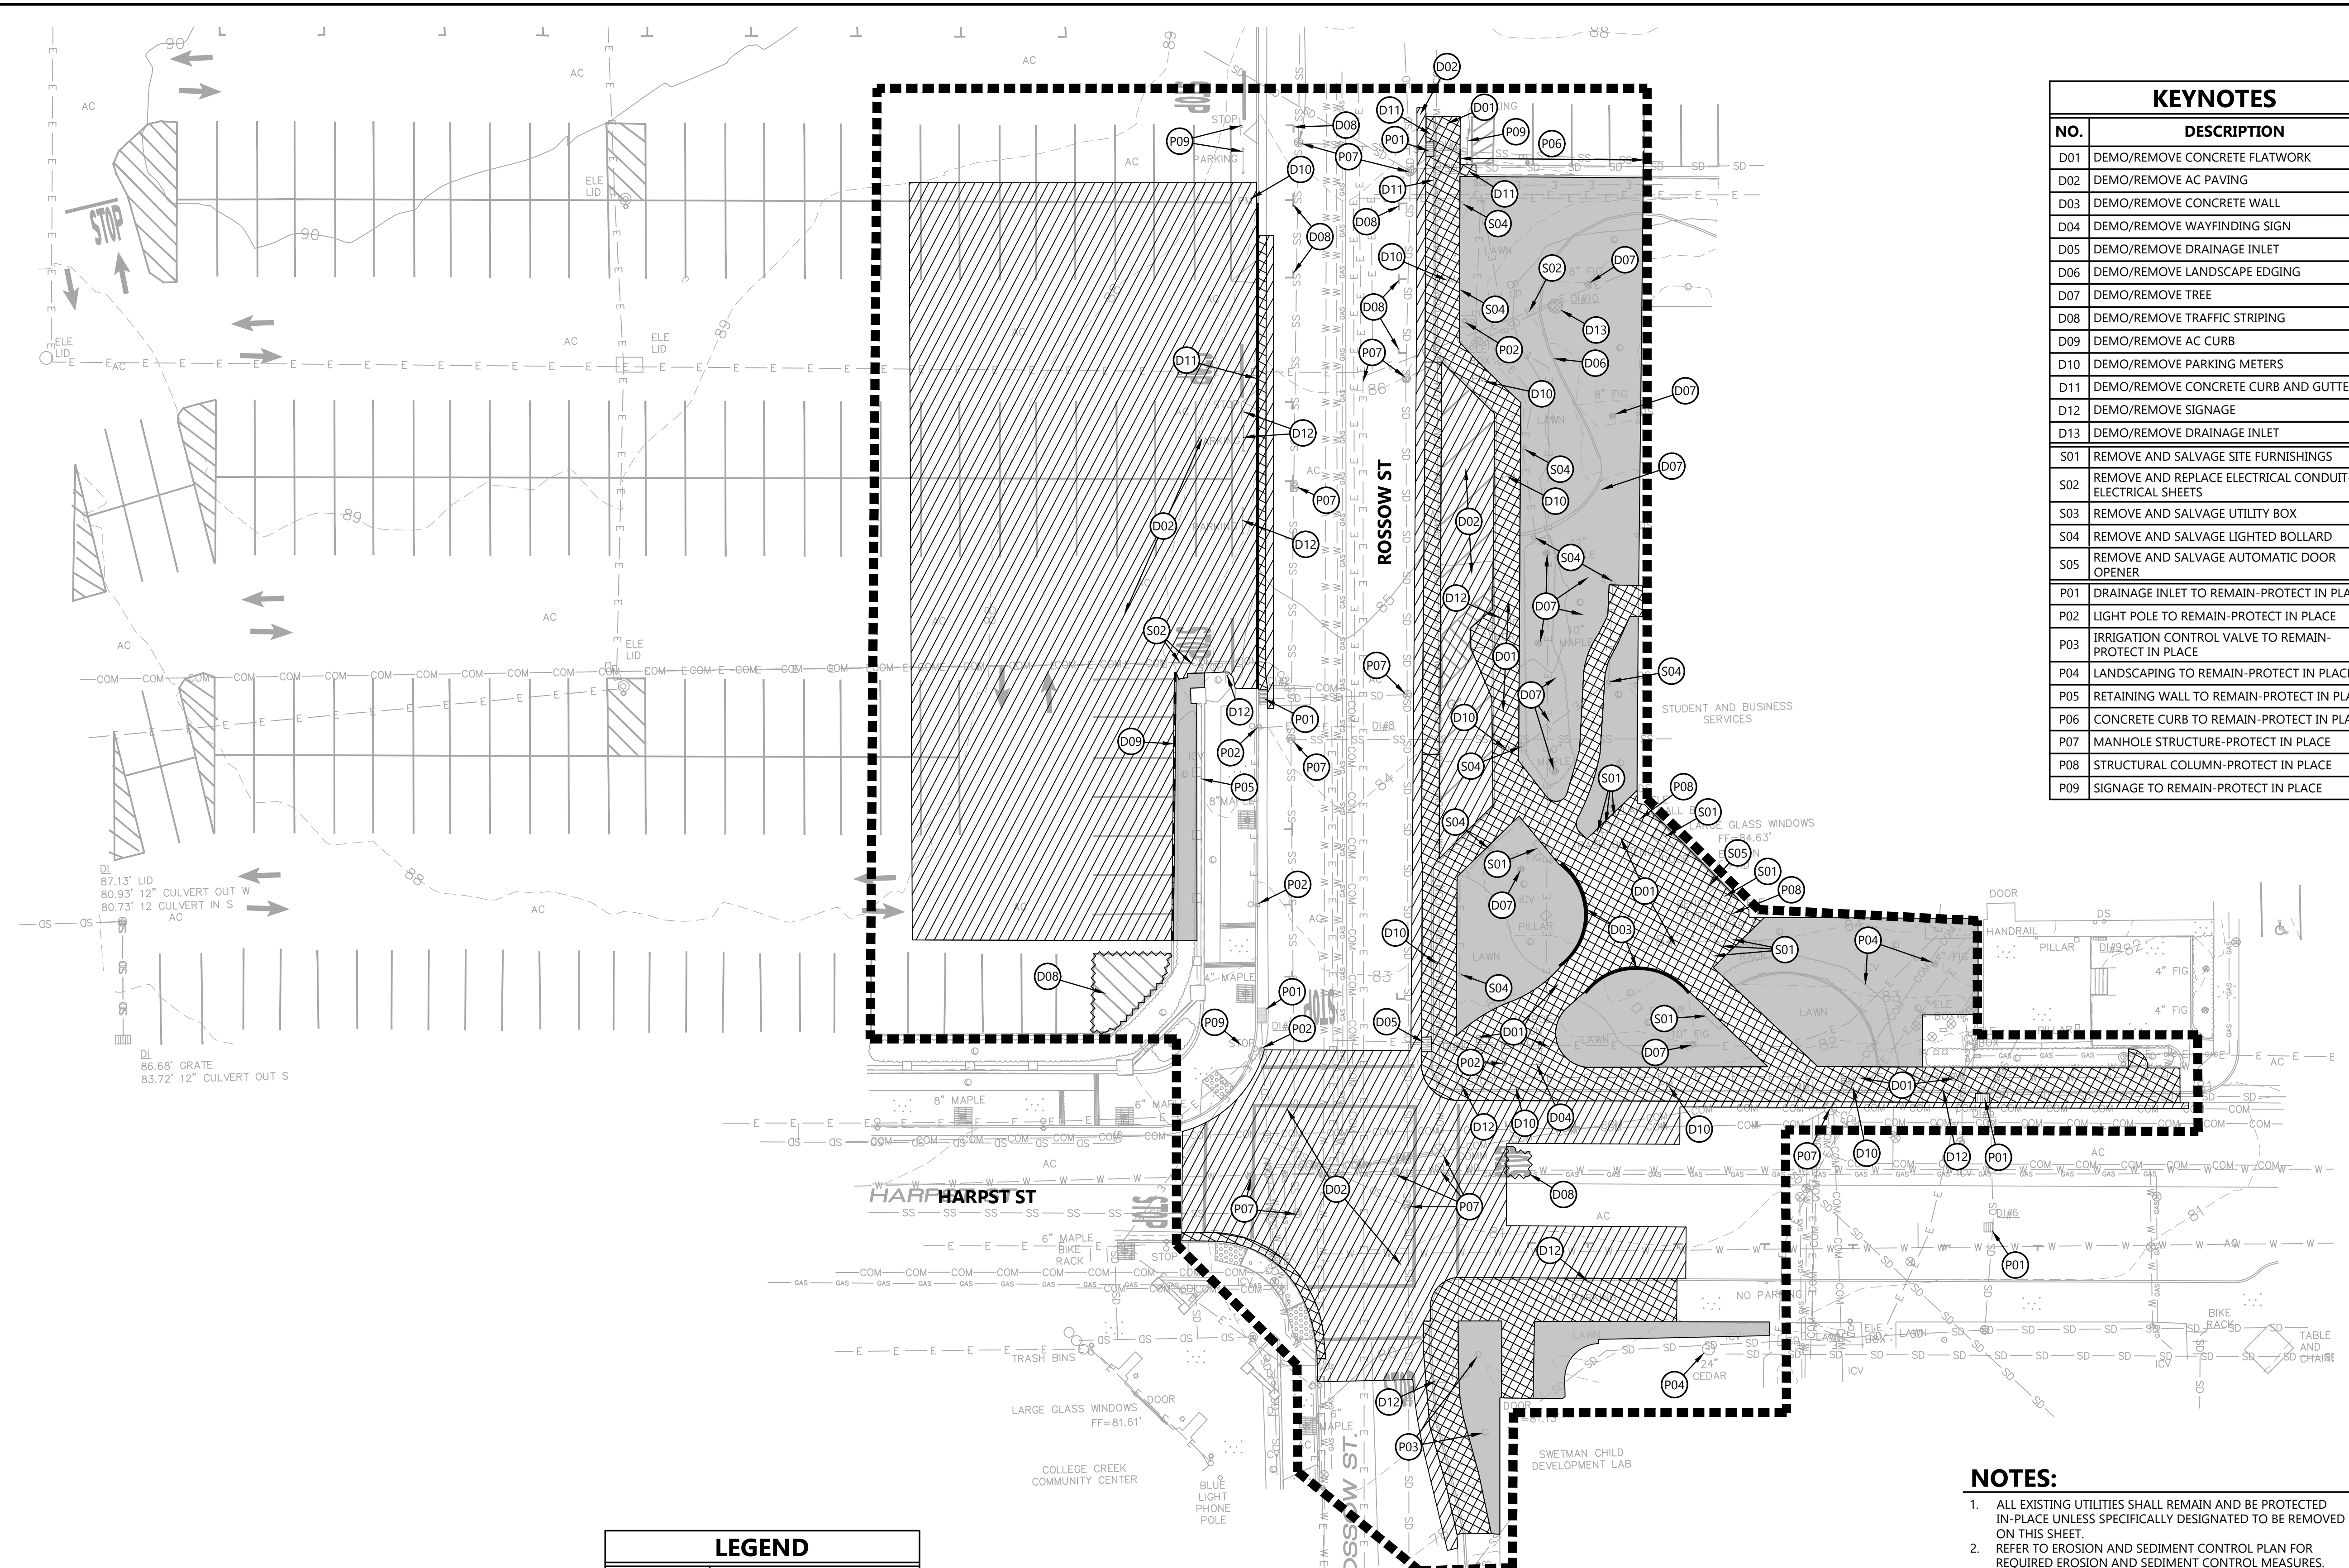

KEYNOTES	
NO.	DESCRIPTION
D01	DEMO/REMOVE CONCRETE FLATWORK
D02	DEMO/REMOVE AC PAVING
D03	DEMO/REMOVE CONCRETE WALL
D04	DEMO/REMOVE WAYFINDING SIGN
D05	DEMO/REMOVE DRAINAGE INLET
D06	DEMO/REMOVE LANDSCAPE EDGING
D07	DEMO/REMOVE TREE
D08	DEMO/REMOVE TRAFFIC STRIPING
D09	DEMO/REMOVE AC CURB
D10	DEMO/REMOVE PARKING METERS
D11	DEMO/REMOVE CONCRETE CURB AND GUTTER
D12	DEMO/REMOVE SIGNAGE
D13	DEMO/REMOVE DRAINAGE INLET
S01	REMOVE AND SALVAGE SITE FURNISHINGS
S02	REMOVE AND REPLACE ELECTRICAL CONDUIT-SEE ELECTRICAL SHEETS
S03	REMOVE AND SALVAGE UTILITY BOX
S04	REMOVE AND SALVAGE LIGHTED BOLLARD
S05	REMOVE AND SALVAGE AUTOMATIC DOOR OPENER
P01	DRAINAGE INLET TO REMAIN-PROTECT IN PLACE
P02	LIGHT POLE TO REMAIN-PROTECT IN PLACE
P03	IRRIGATION CONTROL VALVE TO REMAIN-PROTECT IN PLACE
P04	LANDSCAPING TO REMAIN-PROTECT IN PLACE
P05	RETAINING WALL TO REMAIN-PROTECT IN PLACE
P06	CONCRETE CURB TO REMAIN-PROTECT IN PLACE
P07	MANHOLE STRUCTURE-PROTECT IN PLACE
P08	STRUCTURAL COLUMN-PROTECT IN PLACE
P09	SIGNAGE TO REMAIN-PROTECT IN PLACE

LEGEND	
SYMBOL	DESCRIPTION
	DEMO/REMOVE CONC CURB/WALL
	DEMO/REMOVE AC
	DEMO/REMOVE CONC
	CLEAR AND GRUB
	DEMO AND REMOVE AC CURB
	LIMITS OF WORK

PLAN
1"=20'



- NOTES:**
- ALL EXISTING UTILITIES SHALL REMAIN AND BE PROTECTED IN-PLACE UNLESS SPECIFICALLY DESIGNATED TO BE REMOVED ON THIS SHEET.
 - REFER TO EROSION AND SEDIMENT CONTROL PLAN FOR REQUIRED EROSION AND SEDIMENT CONTROL MEASURES.
 - POTHOLE PRIOR TO CONSTRUCTION TO LOCATE EXISTING UTILITIES. PROTECT EXISTING UTILITIES DURING DEMOLITION AND CONSTRUCTION.
 - REMOVE ALL PARKING FEATURES (INCLUDING BUT NOT LIMITED TO WHEEL STOPS, PARKING METERS, BOLLARDS, SIGNS, ETC.). CLEAR, GRUB, AND REMOVE ALL TREES, VEGETATION, TOPSOIL, AND ORGANIC MATERIAL WITHIN PROJECT SITE.
 - LIMITS OF SIDEWALK AND CURB DEMOLITION SHALL EXTEND TO NEAREST CONTROL JOINT. LIMITS OF AC REMOVAL SHALL BE SAWCUT.
 - SEE ELECTRICAL PLANS FOR ADDITIONAL DEMOLITION INFORMATION.



VERIFY SCALES
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0 1"
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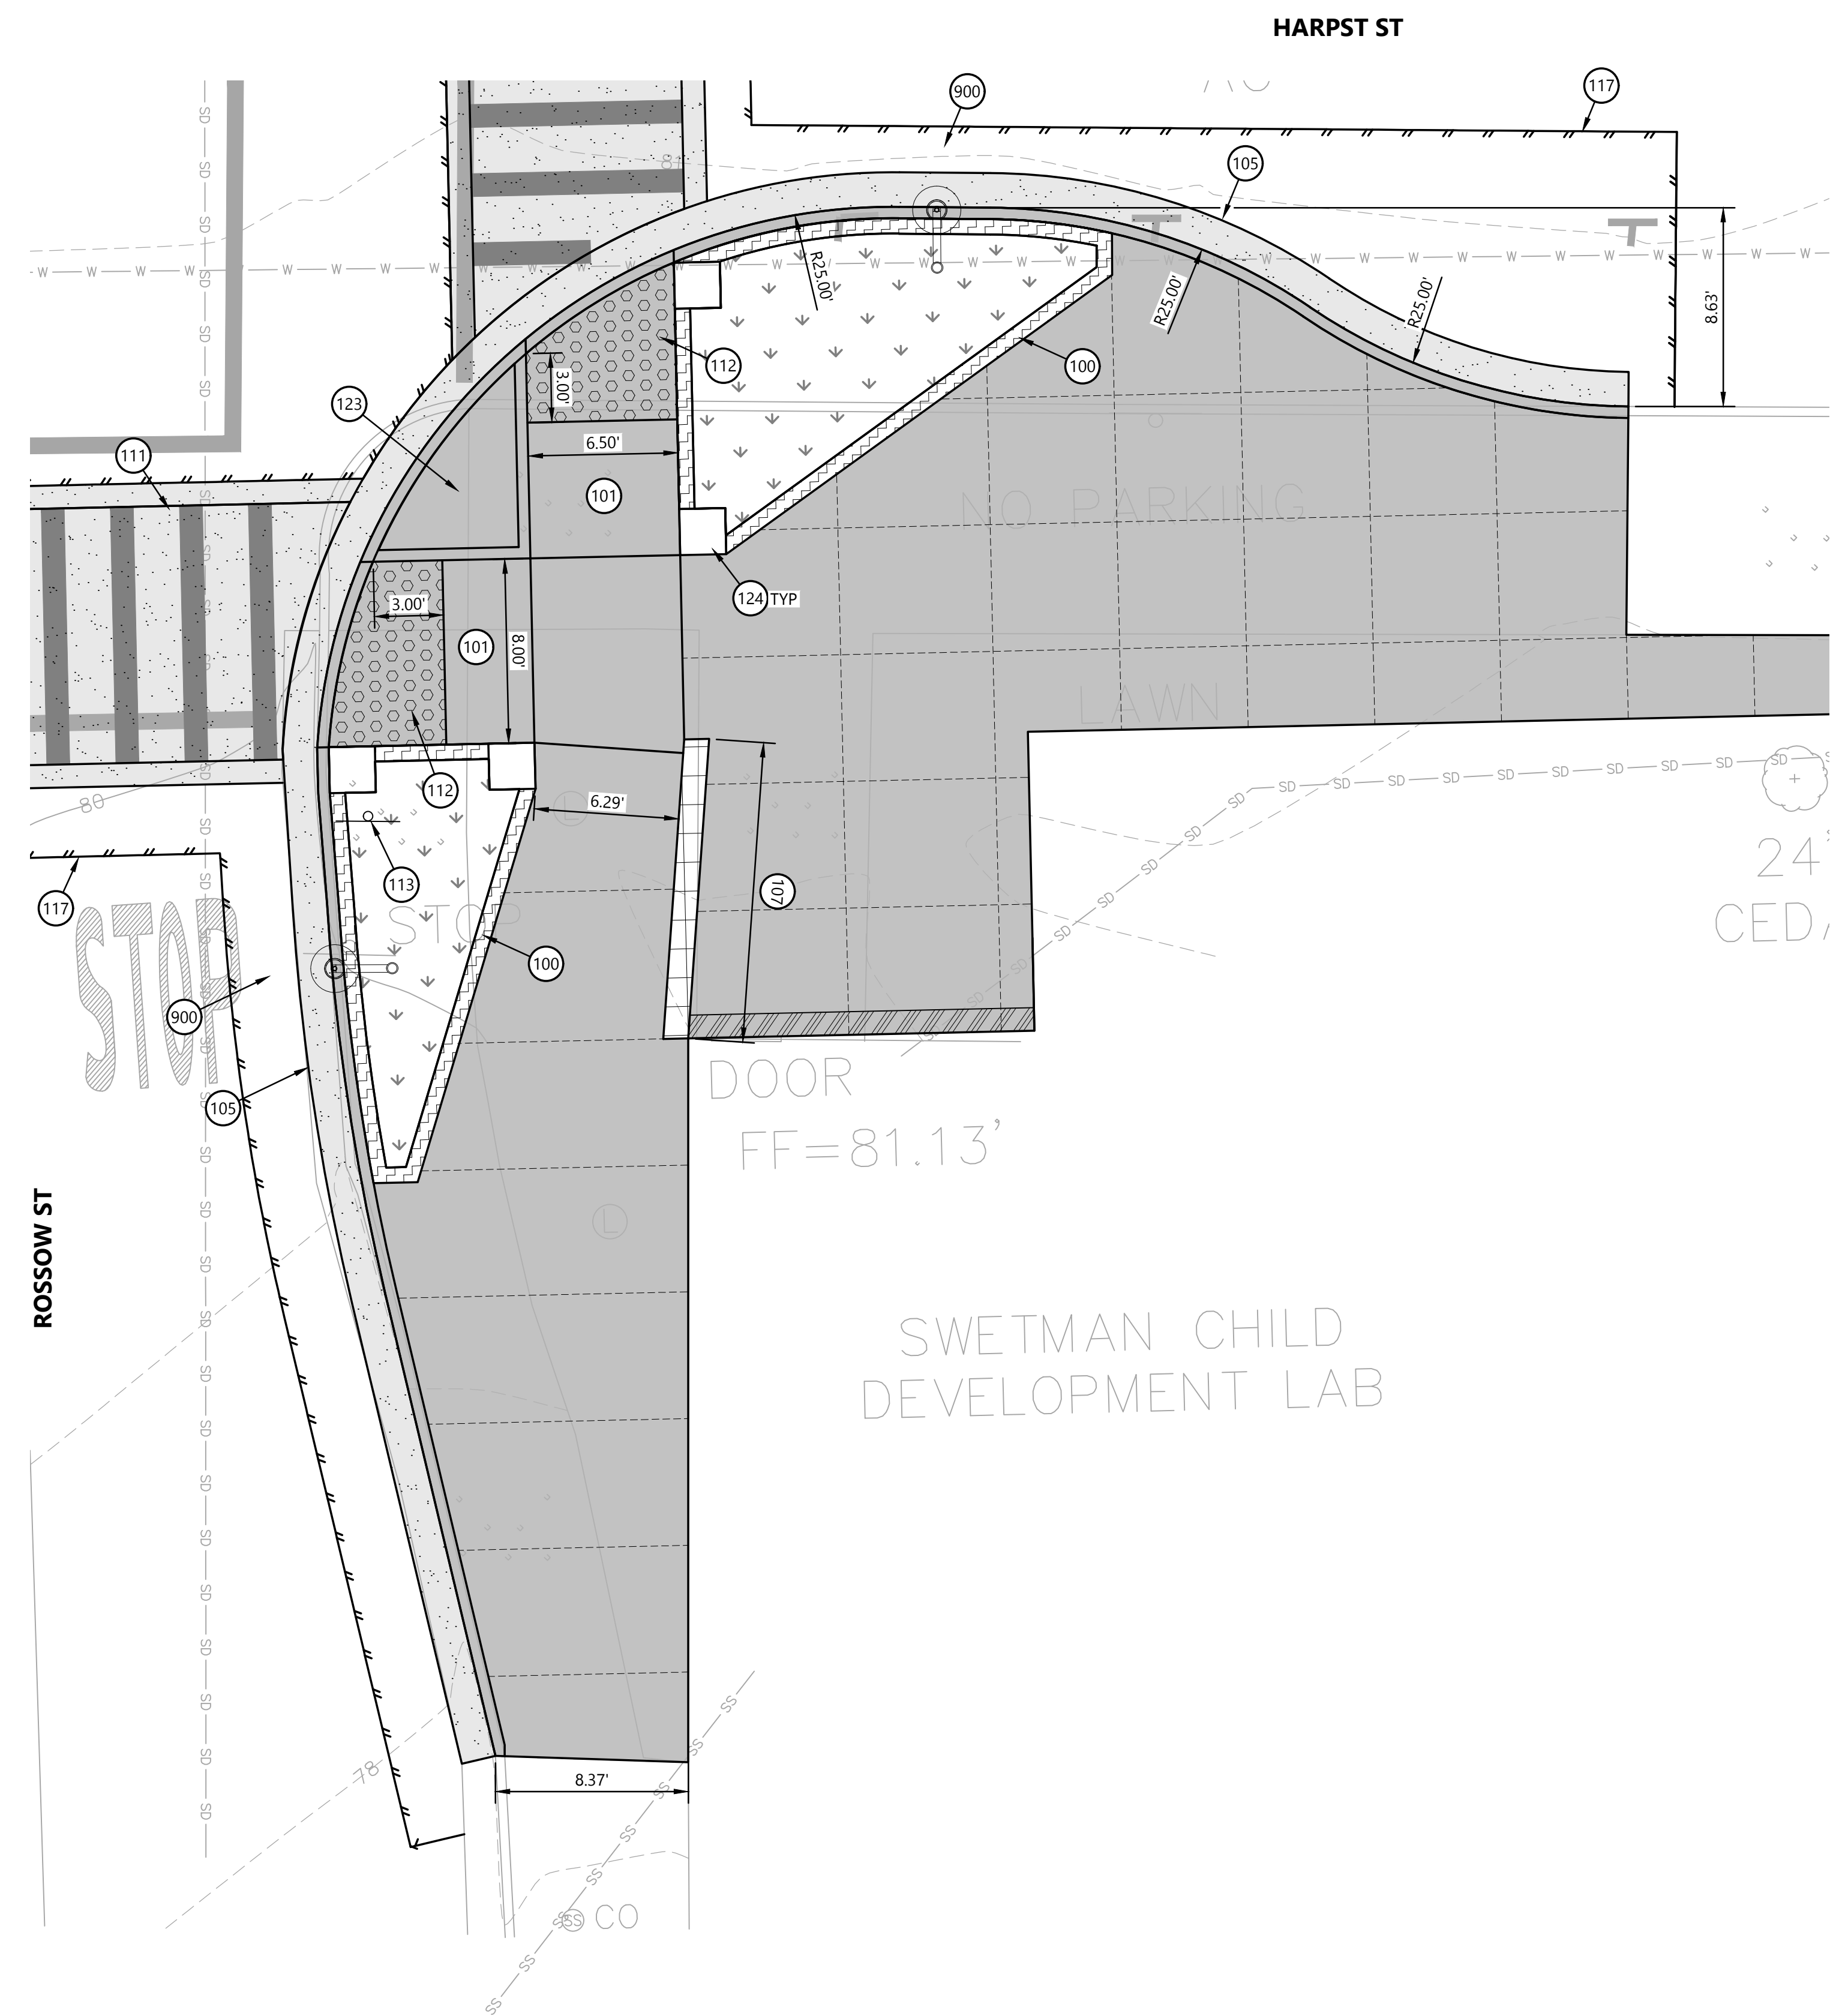
NO.	DATE	REVISION

CAL POLY HUMBOLDT
CPH G11 PARKING LOT
ARCATA, CALIFORNIA

DEMOLITION PLAN

DATE	02/2026	DSGN	CC
PROJ. NO.	025150	DR	CDN/JWF
SHEET		CHK	JSO

C2.0




KEYNOTES			
NO.	DESCRIPTION	DETAIL	SHEET
100	RAISED PLANTER WALL	2 & 3	C8.1
101	CONCRETE CURB RAMP	SEE SHEETS C3.1-C3.2	
102	CONCRETE DRIVEWAY	7	C8.4
103	CONCRETE ACCESSIBLE PARKING STALLS	1 AND 2	C8.6
104	CONCRETE VALLEY GUTTER	7	C8.1
105	CONCRETE CURB AND GUTTER	6	C8.1
106	CONCRETE CURB	5	C8.1
107	CONCRETE SEAT WALL	1	C8.1
108	CONCRETE RETAINING WALL	SEE SHEET C7.0	
109	CONCRETE STAIRS WITH HANDRAIL	1 & 2	C8.5
110	CONCRETE WHEELSTOP	6	C8.4
111	CROSSWALK STRIPING	3	C8.4
112	TRUNCATED DOMES	5	C8.0
113	INSTALL NEW SIGN	SEE ARCH PLANS	
114	REINSTALL SALVAGED SITE FURNISHINGS	-	-
115	4" TRAFFIC STRIPING	-	-
116	PARKING LOT SIGN	SEE ARCH PLANS	
117	AC PAVING	8	C8.1
118	RETAINING CURB	4	C8.1
119	ORNAMENTAL METAL FENCE	1 & 3	C8.2
120	ACCESSIBLE PARKING SIGN	SEE ARCH PLANS	
121	PAVEMENT MARKINGS	1-4	C8.4
122	ADJUST RIM TO MATCH NEW FG	-	-
123	RAISED ISLAND	-	-
124	CONCRETE PLANTER WALL PILASTER	3	C8.1
125	RE-INSTALL AUTOMATIC DOOR OPENER	-	-
126	GRAVEL BAND	5	C8.2
200	DRAINAGE INLET	SEE SHEET C5.0	
201	ACO K100 TRENCH DRAIN (LOAD CLASS C)	SEE SHEET C5.0	
202	SIDEWALK UNDERDRAIN PIPE	SEE SHEET C5.0	
203	SIDEWALK UNDERDRAIN CHANNEL	SEE SHEET C5.0	
900	POLE-MOUNTED LIGHT FIXTURE	SEE ELECTRICAL PLANS	
901	BOLLARD LIGHT FIXTURE	SEE ELECTRICAL PLANS	

LEGEND			
SYMBOL	DESCRIPTION	DETAIL	SHEET
+	PLANTER	SEE LANDSCAPE PLANS	
▬	PEDESTRIAN CONCRETE PAVING	2	C8.0
▬	VEHICULAR CONCRETE PAVING	3	C8.0
•••	TRUNCATED DOMES	5	C8.0
▬▬▬	AC PAVING LIMITS	8	C8.1
---	SCORE JOINT	1	C8.0
▬▬▬	THICKENED EDGE (LANDSCAPE)	8	C8.0
▬▬▬	THICKENED EDGE (EXTERIOR DOORS)	7	C8.0
▬▬▬	CONCRETE SEAT WALL	1	C8.1
▬▬▬	RAISED PLANTER WALL	2 & 3	C8.1
▬▬▬	GRAVEL BAND	5	C8.2

NOTE:
REFER TO ARCHITECTURAL SHEETS FOR SIGNAGE INFORMATION.



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0 1"
IF NOT ONE INCH ON THIS SHEET, ADJUST SCALES ACCORDINGLY

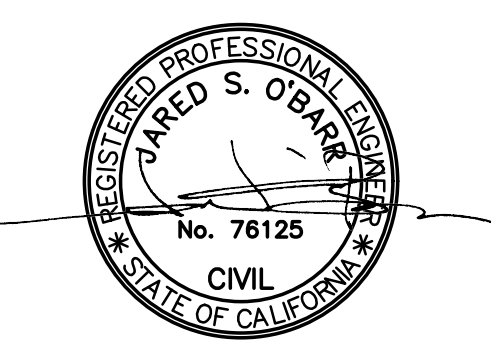

NO.	DATE	REVISION


CAL POLY HUMBOLDT
CPH G11 PARKING LOT
ARCATA, CALIFORNIA

ENLARGED SITE PLAN



DATE	02/2026	DSGN	CC
PROJ. NO.	025150	DR	CDN/JWF
		CHK	JSO

SHEET
C3.3



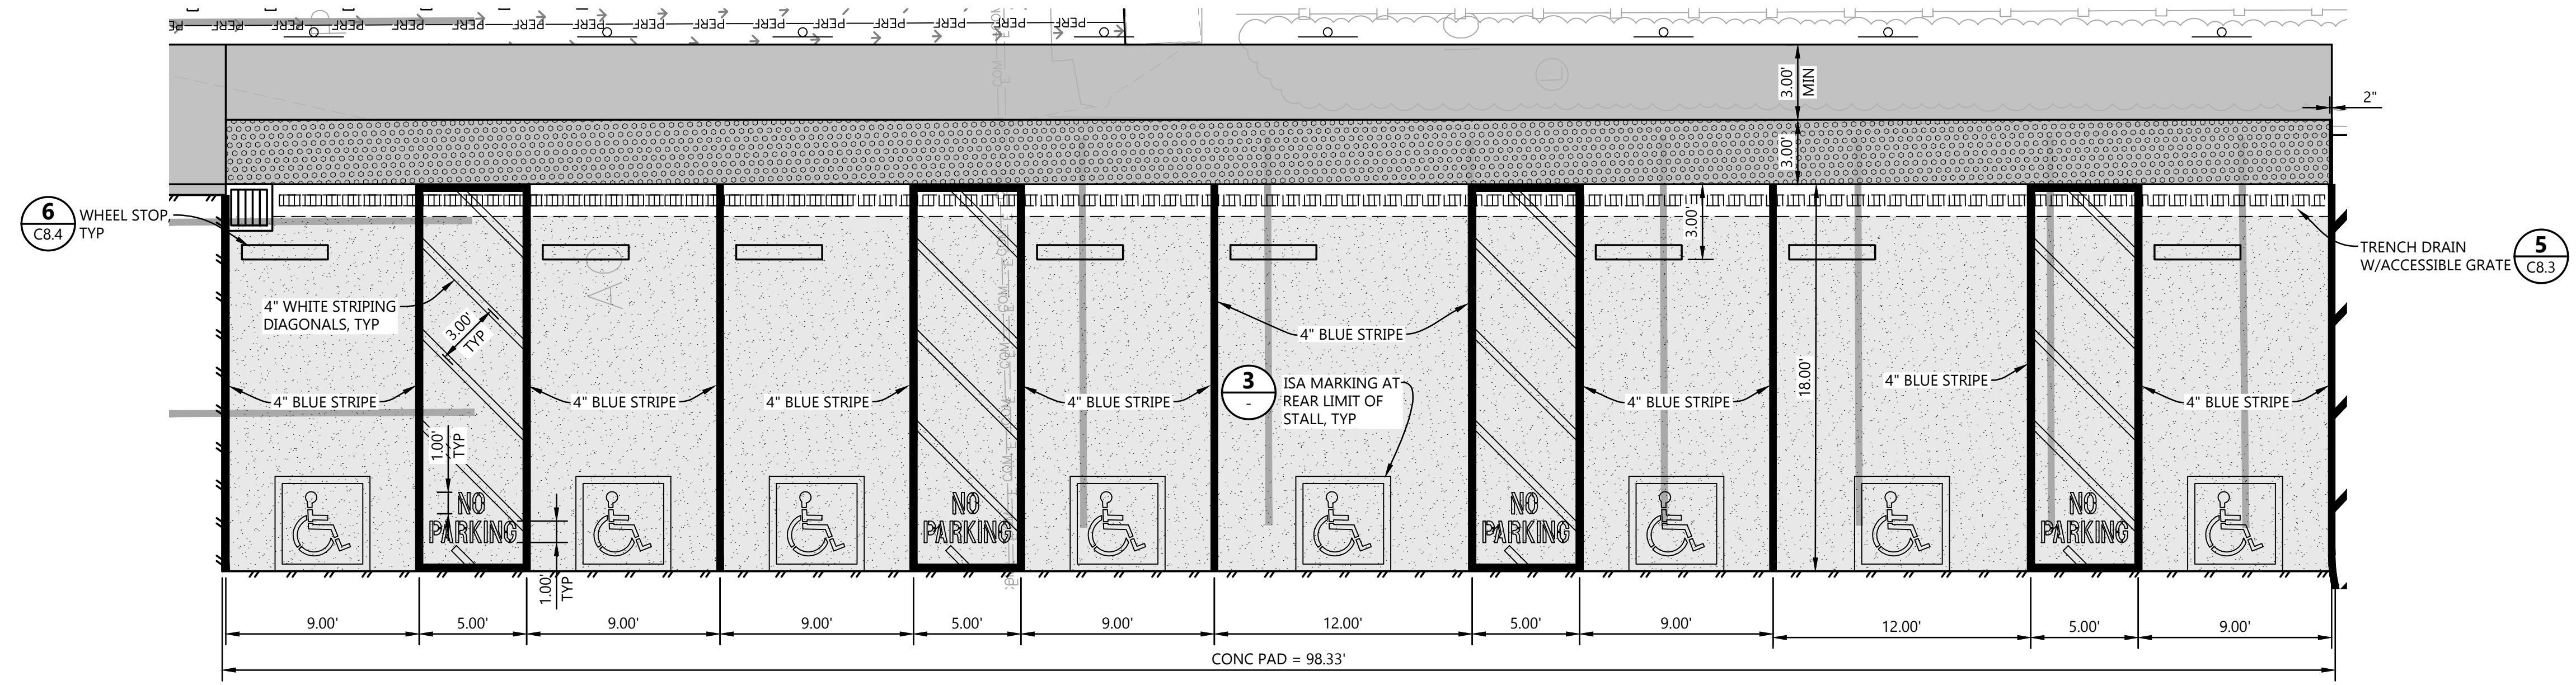


LEGEND

SYMBOL	DESCRIPTION	DETAIL	SHEET
*****	PLANTER		
[Pattern]	PEDESTRIAN CONCRETE PAVING	2	C8.0
[Pattern]	VEHICULAR CONCRETE PAVING	3	C8.0
[Pattern]	TRUNCATED DOMES	5	C8.0
==	AC PAVING LIMITS		


WESTERN ACCESSIBLE PARKING

NTS

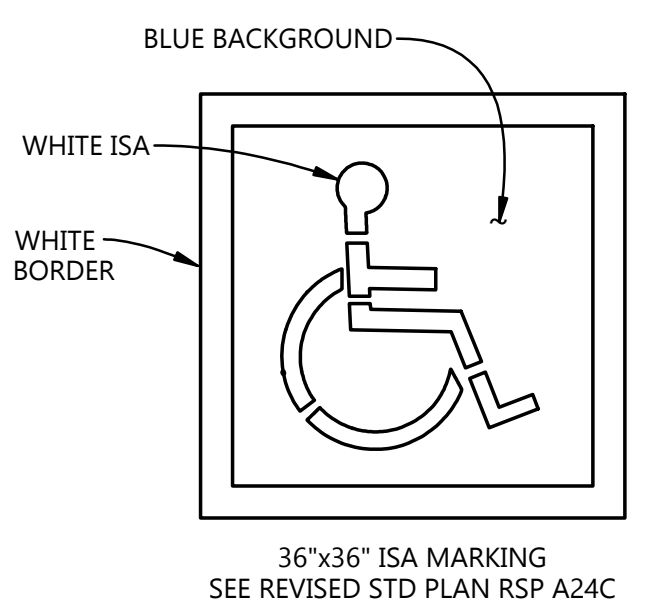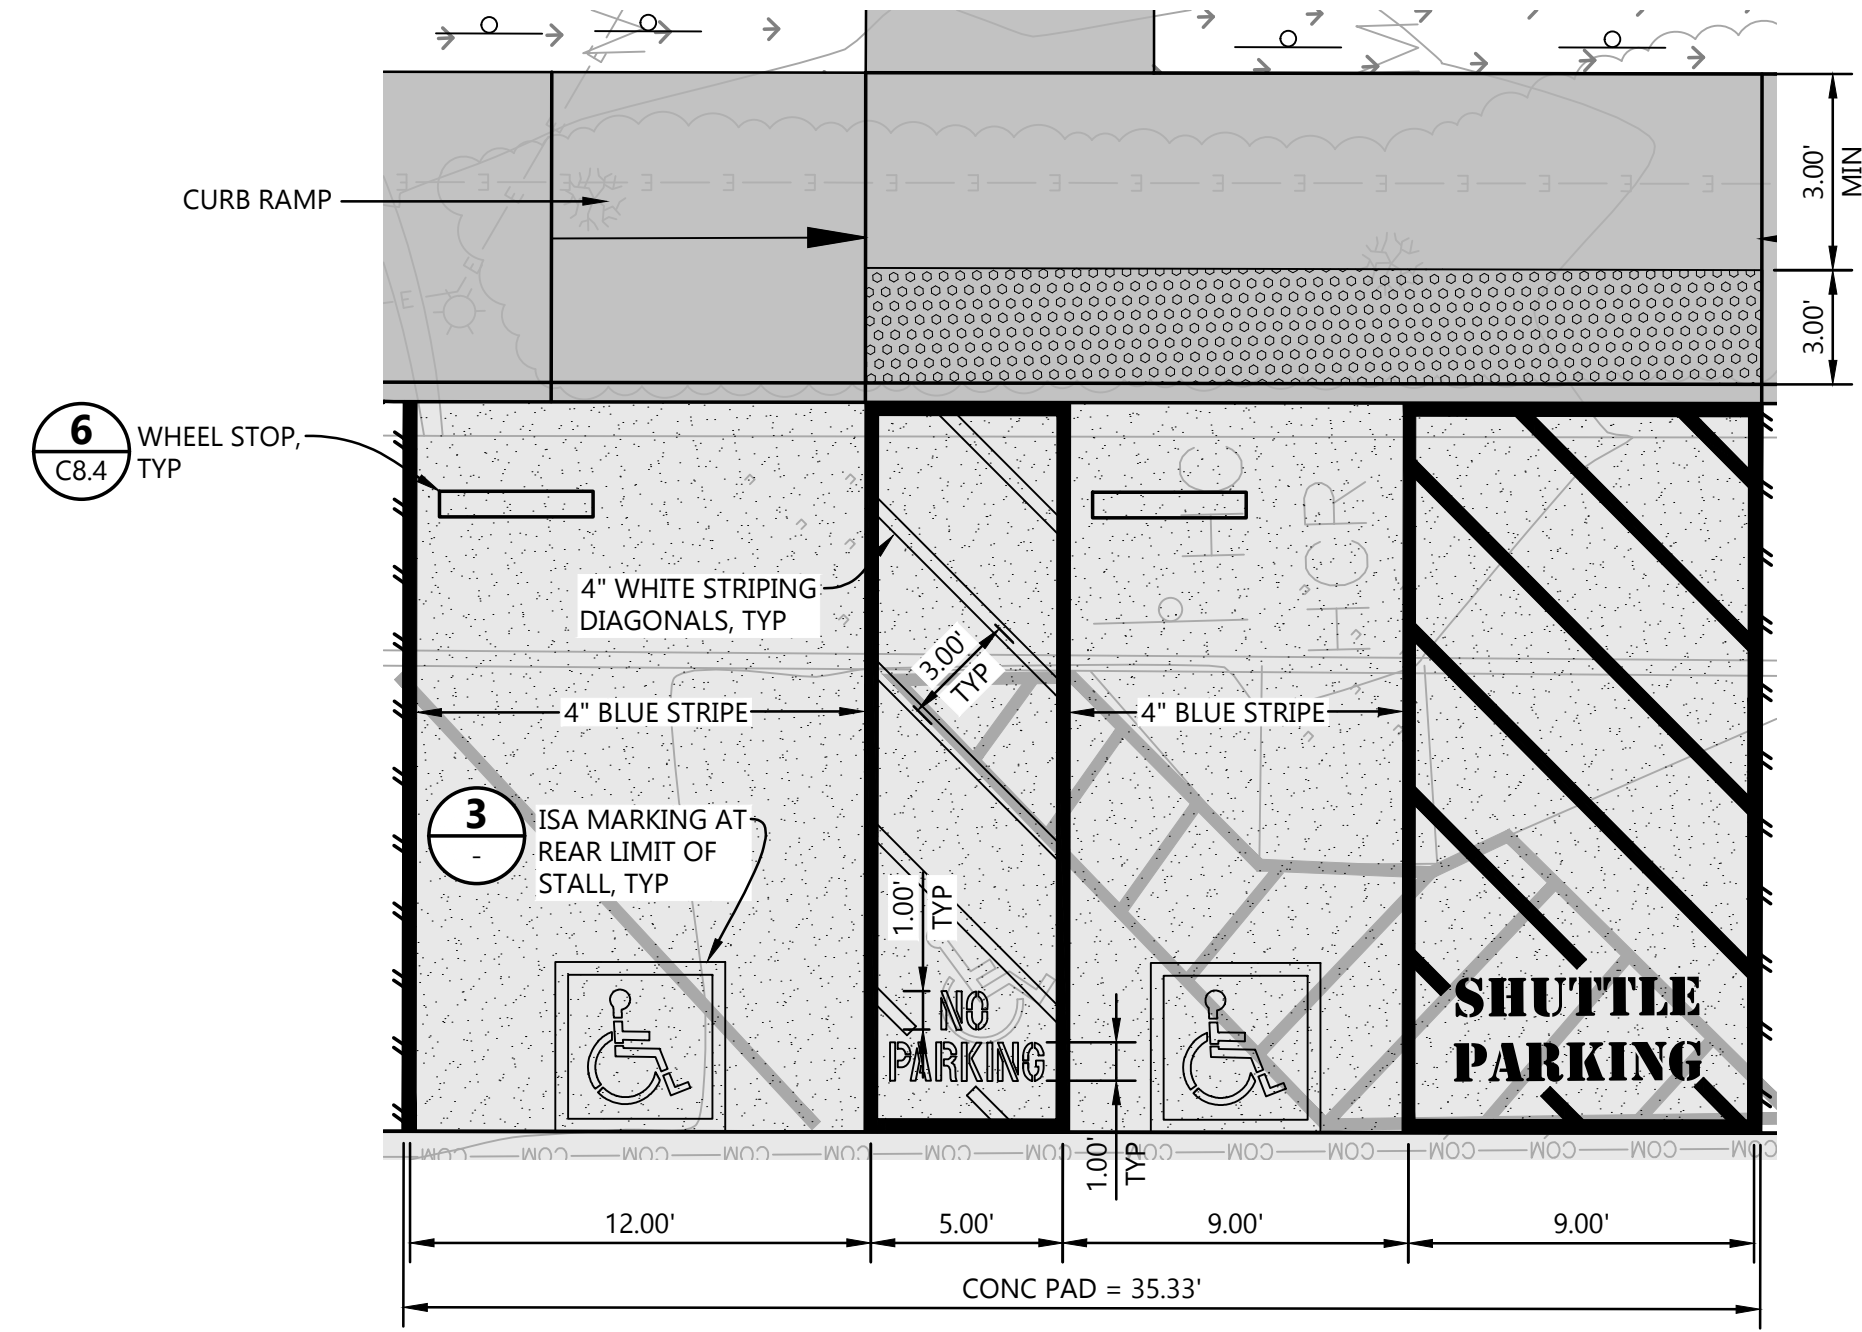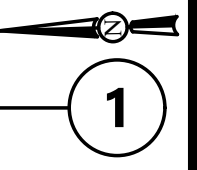


ISA MARKING

NTS

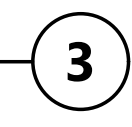

LEGEND

SYMBOL	DESCRIPTION	DETAIL	SHEET
*****	PLANTER		
[Pattern]	PEDESTRIAN CONCRETE PAVING	2	C8.0
[Pattern]	VEHICULAR CONCRETE PAVING	3	C8.0
[Pattern]	TRUNCATED DOMES	5	C8.0
==	AC PAVING LIMITS		

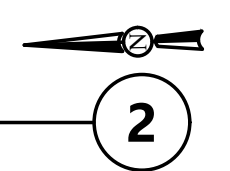

EASTERN ACCESSIBLE PARKING

NTS



812 W. WABASH AVE.
EUREKA, CA. 95501
WWW.SHN-ENGR.COM
707-441-8855

VERIFY SCALES
BAR IS ONE INCH ON ORIGINAL DRAWING
0 1"
IF NOT ONE INCH ON THIS SHEET, ADJUST SCALES ACCORDINGLY



NO.	DATE	REVISION

CAL POLY HUMBOLDT
CPH G11 PARKING LOT
ARCATA, CALIFORNIA

DETAILS



DATE	02/2026	DSGN	CC
PROJ. NO.	025150	DR	CDN/JWF
SHEET		CHK	JSO

C8.6

SAVED: 2/25/2026 1:42 PM JFOSTER, PLOTTED: 2/25/2026 1:55 PM JOHN FOSTER
P:\Eureka\2025\025150-CPH-G11-Parking-Lot\Drawings\025150-ADA-DTLS.dwg

